# 08 - PLUMBING INDEX OF DRAWINGS

DRAWING NUMBER	DRAWING TITLE	DRAWING NUMBER	DRAWING TITLE
P-001	INDEX OF DRAWINGS		
P-002	LEGEND & GENERAL NOTES		
P-003	OFFICE AREA PLUMBING SUPPLY		
P-004	BAY AREA PLUMBING SUPPLY		
P-005	OFFICE AREA PLUMBING DRAINAGE		
P-006	BAY AREA PLUMBING DRAINAGE		
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P-009	PLUMBING DRAINAGE DETAILS		
P-010	MISCELLANEOUS PLUMBING DETAILS		
P-011	OIL-WATER SEPARATOR		


THE DESIGN APPEARS TO CONFORM TO APPLICABLE CRITERIA. APPROVAL IS NOT TO BE CONSTRUED TO MEAN THAT ALL ASPECTS OF THE DESIGN HAVE BEEN PERSONALLY CHECKED BY THE UNDERSIGNED.

TRANSPORTATION PRINCIPAL ENGINEER

					DESIG
				THE INFORMATION, INCLUDING ESTIMATED	
				QUANTITIES OF WORK, SHOWN ON THESE SHEETS IS BASED ON LIMITED	CHECK
				INVESTIGATIONS BY THE STATE AND IS	
				IN NO WAY WARRANTED TO INDICATE THE CONDITIONS OF ACTUAL QUANTITIES	
				OF WORK WHICH WILL BE REQUIRED.	
RFV/	DATE	REVISION DESCRIPTION	SHEET NO	Plotted Date: 6/10/2015	1

	DESIGNER/DRAFTER:
,	JAB
	CHECKED BY:
	JWW

NOT TO SCALE

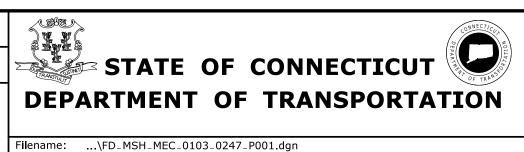

SIGNATURE/ BLOCK:	PRO
OFFICE OF ENGINEERING	
APPROVED BY:	
Amy M.D.	

OCCUM MAINTENANCE FACILITY TOWN:

OCCUM

DRAWING TITLE:

INDEX OF DRAWINGS

PROJECT NO.

103-247

DRAWING NO.

P-001

SHEET NO.

08.01

### LEGEND

### **PIPING**

	COLD WATER
—— SV——	COMBINATION WASTE AND VENT
——————————————————————————————————————	COMPRESSED AIR
D	DRAIN LINE
———F——	FIRE LINE
	HOT WATER
R	HOT WATER RETURN
——— IW ———	INDIRECT DRAIN
——MU——	MAKEUP WATER
——S——	SANITARY DRAIN ABOVE FLOOR OR GRADE
S	SANITARY DRAIN BELOW FLOOR OR GRADE
——— SP ———	SPRINKLER / STANDPIPE
—— ST——	STORM DRAIN ABOVE FLOOR OR GRADE
ST	STORM DRAIN BELOW FLOOR OR GRADE
T	TEMPERED WATER
••••••	VENT

### **FITTINGS**

<u> </u>	BRANCH OFF TOP OF MAIN
<del></del>	PIPE RISER DOWN
0—	PIPE RISER UP
$\dashv$   $\vdash$	UNION

————— WASTE

# VALVEC

	<u>VALVES</u>	
-∳-	AIR LINE	
$\phi^{BMA}$	BACK WATER	
<del>-</del>  Ф -	BALL	
4 [+	BUTTERFLY	
4	CHECK	
卓	FOOT	
Б	GAS	
- <del>[</del> Ø -	NON-SLAM CHECK	
$\boxtimes$	OUTSIDE SCREW & YOKE (OS&Y)	
4 <u>4</u> ⊦	PLUG	
<b>♣</b>	PRESSURE AND TEMPERATURE RELIEF	
-₩-	PRESSURE REDUCING	
- <b>\$</b> -	THERMOSTATIC WATER CONTROL SET AT 110°	F
<u>-</u> b	TRIPLE DUTY	

# LEGEND CONT.

### PIPING SPECIALTIES

	CAP CLEANOUT CLEANOUT AT GRADE DIAL TYPE THERMOMETER DRAW OFF DRAIN
· ////	EXPANSION JOINT
	FILTER
$\Diamond$	FIRE HYDRANT OR SIAMESE
	FLOOR DRAIN WITH P-TRAP
	FLOOR DRAIN WITH OUT P-TRAP
<del>-</del>	HOSE BIBB OR WALL HYDRANT
451	IMMERSION SENSOR IN SENSOR WELL
<b>⊘</b> _I	PRESSURE GAUGE WITH BRASS PETCOCK
RD RD R.T.	ROOF DRAIN RUNNING TRAP STRAIGHT TYPE THERMOMETER
+>+	STRAINER
31/1	VACUUM BREAKER
倬	WATER HAMMER ARRESTOR (WITH ACCESS DOOR IF REQUIRED)

REDUCED PRESSURE PRINCIPAL BACKFLOW PREVENTER

BALANCING VALVE WITH GAUGE CONNECTIONS

# **PLUMBING FIXTURES**

1	EYE/FACE WASH UNIT
	KITCHEN SINK
	LAVATORY
	SERVICE BASIN
	SHOWER STALL WITH SHOWER HEAD
₹7	URINAL
	WASH FOUNTAIN
<b>©</b>	WATER CLOSET
9	WATER COOLER

# **MISCELLANEOUS**

1	$^{1\!\!}/_{2}$ " COLD WATER DOWN TO $^{1\!\!}/_{2}$ " HOSE BIBB 32" ABOVE FLOOR. INSTALL BALL VALVE SHUTOFF PRIOR TO HOSE BIBB. INSTALL VACUUM BREAKER AT HOSE BIBB.
2	$^{3}/_{4}$ " HOT WATER DOWN TO $^{3}/_{4}$ " HOSE BIBB 32" ABOVE FLOOR. INSTALL BALL VALVE SHUTOFF PRIOR TO HOSE BIBB. INSTALL VACUUM BREAKER AT HOSE BIBB.
3	$1\frac{1}{2}$ " COLD WATER DOWN TO $1\frac{1}{2}$ " FEMALE NPT TO MALE NST HEX NIPPLE, 32" ABOVE FLOOR. INSTALL BALL VALVE SHUTOFF PRIOR TO ADAPTER.
Ę	CENTER LINE
CA	COMPRESSED AIR DROP
-[]-	DRYER
-dP	PRESSURE SWITCH

# **ABBREVIATIONS**

ADD'L	ADDITIONAL
AFF	ABOVE FINISHED FLOOR
AVG	AVERAGE
CI CLG CO CSBV CW	CAST IRON CEILING CLEAN OUT COMBINATION SHUTOFF & BALANCE VALVE DOMESTIC COLD WATER
dia	DIAMETER
DN	DOWN
DWG	DRAWING
EL	ELEVATION
EWT&B	EACH WAY TOP & BOTTOM
FCO FHC FSP FT	FLOOR CLEANOUT FIRE HOSE CABINET FIRE STANDPIPE FOOT/FEET
GA	GAUGE
GAL	GALLON
GALV	GALVANIZE
GPM	GALLONS PER MINUTE
HP	HIGH POINT
HORZ	HORIZONTAL
HW	DOMESTIC HOT WATER
id	INSIDE DIAMETER
INV	INVERT
max	MAXIMUM
MH	MANHOLE
min	MINIMUM
NO	NUMBER
NOM	NOMINAL
NTS	NOT TO SCALE
oc od OPP OWSJ	ON CENTER OUTSIDE DIAMETER OPPOSITE OPEN WEB STEEL JOIST
PEX	CROSSLINKED POLYETHYLENE
PLCS	PLACES
PVC	POLYVINYL CHLORIDE
R	RETURN
rad	RADIUS
REINF	REINFORCED
REQ'D	REQUIRED
RL	RAIN LEADER
S	SUPPLY
SAN	SANITARY
SQ	SQUARE
STD	STANDARD
T&B TOS TW TPS TD TYP	TOP & BOTTOM TOP OF SLAB TEMPERED WATER TRAP PRIMER SYSTEM TRENCH DRAIN TYPICAL
UG	UNDERGROUND
UON	UNLESS OTHERWISE NOTED
UST	UNDERGROUND STORAGE TANK
V	VENT
VERT	VERTICAL
VIF	VERIFY IN FIELD
VTR	VENT THRU ROOF
W/	WITH
WCO	WALL CLEANOUT
W	WASTE

PLUMBING FIXTURE SCHEDULE							
	MINIMUM PIPE SIZES						
NO.	FIXTURE	SANITARY	VENT	HW	CW		
1	WATER CLOSET	4"	2"		1"		
2	KITCHEN SINK	2"	$1^{1/2}$ "	1/2"	1/2"		
3	LAVATORY	2"	1 <sup>1</sup> / <sub>2</sub> "	1/2"	1/2"		
4	WASH FOUNTAIN	2"	2"	1"	1"		
(5)	URINAL	2"	$1\frac{1}{2}$ "		3/4"		
6	DRINKING FOUNTAIN	2"	1 ½"		1/2"		
7	SHOWER	2"	1 ½"	1/2"	1/2"		
8	SERVICE BASIN	3"	2"	3/4"	1/2"		
9	FLOOR DRAIN	3"	2"				
10	SEALED EQUIPMENT DRAIN	3"	2"				
11	ACCESSIBLE WATER CLOSET	4"	2"		1"		
12	ACCESSIBLE LAVATORY	2"	$1\frac{1}{2}$ "	1/2"	1/2"		
13	ACCESSIBLE URINAL	2"	$1\frac{1}{2}$ "		3/4"		
14	EYE/FACE WASH UNIT			1/2"	1/2"		
15	ACCESSIBLE WATER COOLER	2"	1 <sup>1</sup> / <sub>2</sub> "		1/2"		
	NOTE: ALL FIXTURES TO BE PROVIDED WITH TRAPS AND SHUTOFF VALVES.						

### **GENERAL NOTES**

- 1. THE INSTALLER SHALL NOTIFY THE ENGINEER OF ANY DISCREPANCIES BETWEEN FIELD CONDITIONS AND THE CONTRACT BEFORE PROCEEDING WITH THAT PORTION OF THE WORK. FAILURE TO NOTIFY THE ENGINEER WILL NOT RELIEVE THE INSTALLER OF RESPONSIBILITY. THE INSTALLER SHALL CORRECT ALL WORK ARISING FROM SUCH FAILURE TO COORDINATE DISCREPANCIES TO THE SATISFACTION OF THE ENGINEER WITHOUT ADDED COST TO THE OWNER.
- 2. PLUMBING INSTALLER SHALL COORDINATE WITH ALL NECESSARY INSTALLERS TO PREVENT INSTALLATION CONFLICTS.
- 3. OPENINGS FOR PENETRATIONS IN SLABS AND WALLS SHALL BE DRILLED TO ACCOMMODATE PIPE SLEEVES FOR THE PASSAGE OF PIPES. HOLE TOLERANCES SHALL MEET REQUIREMENTS OF SLEEVE MANUFACTURER. EXACT LOCATIONS SHALL BE FIELD COORDINATED TO CLEAR BEAMS AND REINFORCEMENT BARS.
- 4. WHERE PIPES PASS THROUGH FINISHED SURFACES OF FLOORS, CEILINGS, ROOFS, AND WALLS, PROVIDE PIPE SLEEVES AND ESCUTCHEON PLATE/FRAMES.
- 5. WHERE PIPES PASS THROUGH EXPOSED SURFACES, PROVIDE PIPE SLEEVES, SEAL AROUND OPENINGS, AND FINISH THE OPENINGS. FIRE SEAL WHERE PIPES PASS THROUGH FIRE RATED CONSTRUCTION. FIRE SEAL SHALL MATCH THE FIRE RATING OF THE ADJACENT CONSTRUCTION.
- 6. PROVIDE SHUTOFF VALVES AND UNIONS/FLANGES AT BASE OF ALL RISERS, MAINS, BRANCHES, AND CONNECTIONS TO ISOLATE FOR MAINTENANCE PURPOSES.
- 7. PROVIDE ACCESS DOORS FOR SERVICE ACCESS TO VALVES, AIR VENTS, AND OTHER ACCESSORIES IN CONCEALED SPACES, FOR MAINTENANCE AND INSPECTION. PROVIDE FIRE RATED DEVICES MATCHING THE ADJACENT CONSTRUCTION IN FIRE RATED CONSTRUCTION.
- 8. PROVIDE DRAIN VALVES WITH HOSE THREADS AT ALL LOW POINTS OF PIPING AND AIR VENTS AT ALL HIGH POINTS OF PIPING.
- 9. UNLESS OTHERWISE INDICATED, ALL BRANCH PIPING SHALL BE OFF THE BOTTOM OF THE MAIN PIPING RUN.
- 10. REFER TO SUPPORTING DOCUMENTS SUBSET FOR PAY LIMITS FOR MAJOR LUMP SUM ITEM (MLSI). EXCAVATION FOR PLUMBING SYSTEMS WITHIN THESE LIMITS IS INCLUDED FOR PAYMENT IN THE MLSI. THERE WILL BE NO SEPARATE PAYMENT FOR EXCAVATION FOR THESE SYSTEMS.
- 11. METHODS OF ATTACHMENT OF SEISMIC RESTRAINT CABLES SHALL COMPLY WITH THE FOLLOWING:
  - a. TO EQUIPMENT: BOLT ANGLE CLIPS TO SUSPENDED EQUIPMENT ADJACENT TO THE HANGER RODS. ORIENT THE FOUR SEISMIC CABLES 90 DEG TO EACH OTHER. ATTACH SEISMIC CABLES TO ANGLE CLIPS IN ACCORDANCE WITH MANUFACTURER'S INSTALLATION INSTRUCTIONS.
  - b. TO STRUCTURE: ATTACH SEISMIC CABLE TO TOP CHORD OF ROOF JOISTS WITH APPROPRIATE FASTENING DEVICES. WELDING, BURNING, OR DRILLING OF THE ROOF JOISTS SHALL NOT BE PERMITTED. THE SEISMIC CABLE SHALL BE DRAWN TAUT BUT SHALL NOT DISPLACE THE UNITS. ATTACHMENT TO BOTTOM CHORD OF ROOF JOISTS SHALL NOT BE PERMITTED. PROVIDE DESIGNER WITH METHOD OF ATTACHMENT TO ROOF JOISTS FOR APPROVAL.

	THE INFORMATION, INCLUDING ESTIMATED QUANTITIES OF WORK, SHOWN ON THESE SHEETS IS BASED ON LIMITED INVESTIGATIONS BY THE STATE AND IS IN NO WAY WARRANTED TO INDICATE
	THE CONDITIONS OF ACTUAL QUANTITIES OF WORK WHICH WILL BE REQUIRED.

REVISION DESCRIPTION

REV. DATE


SHEET NO. Plotted Date: 6/10/2015

JAB JWW

NOT TO SCALE



Filename: ...\FD\_MSH\_MEC\_0103\_0247\_P002.dgn

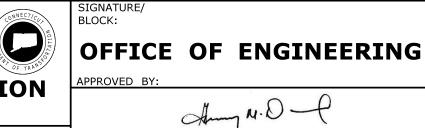


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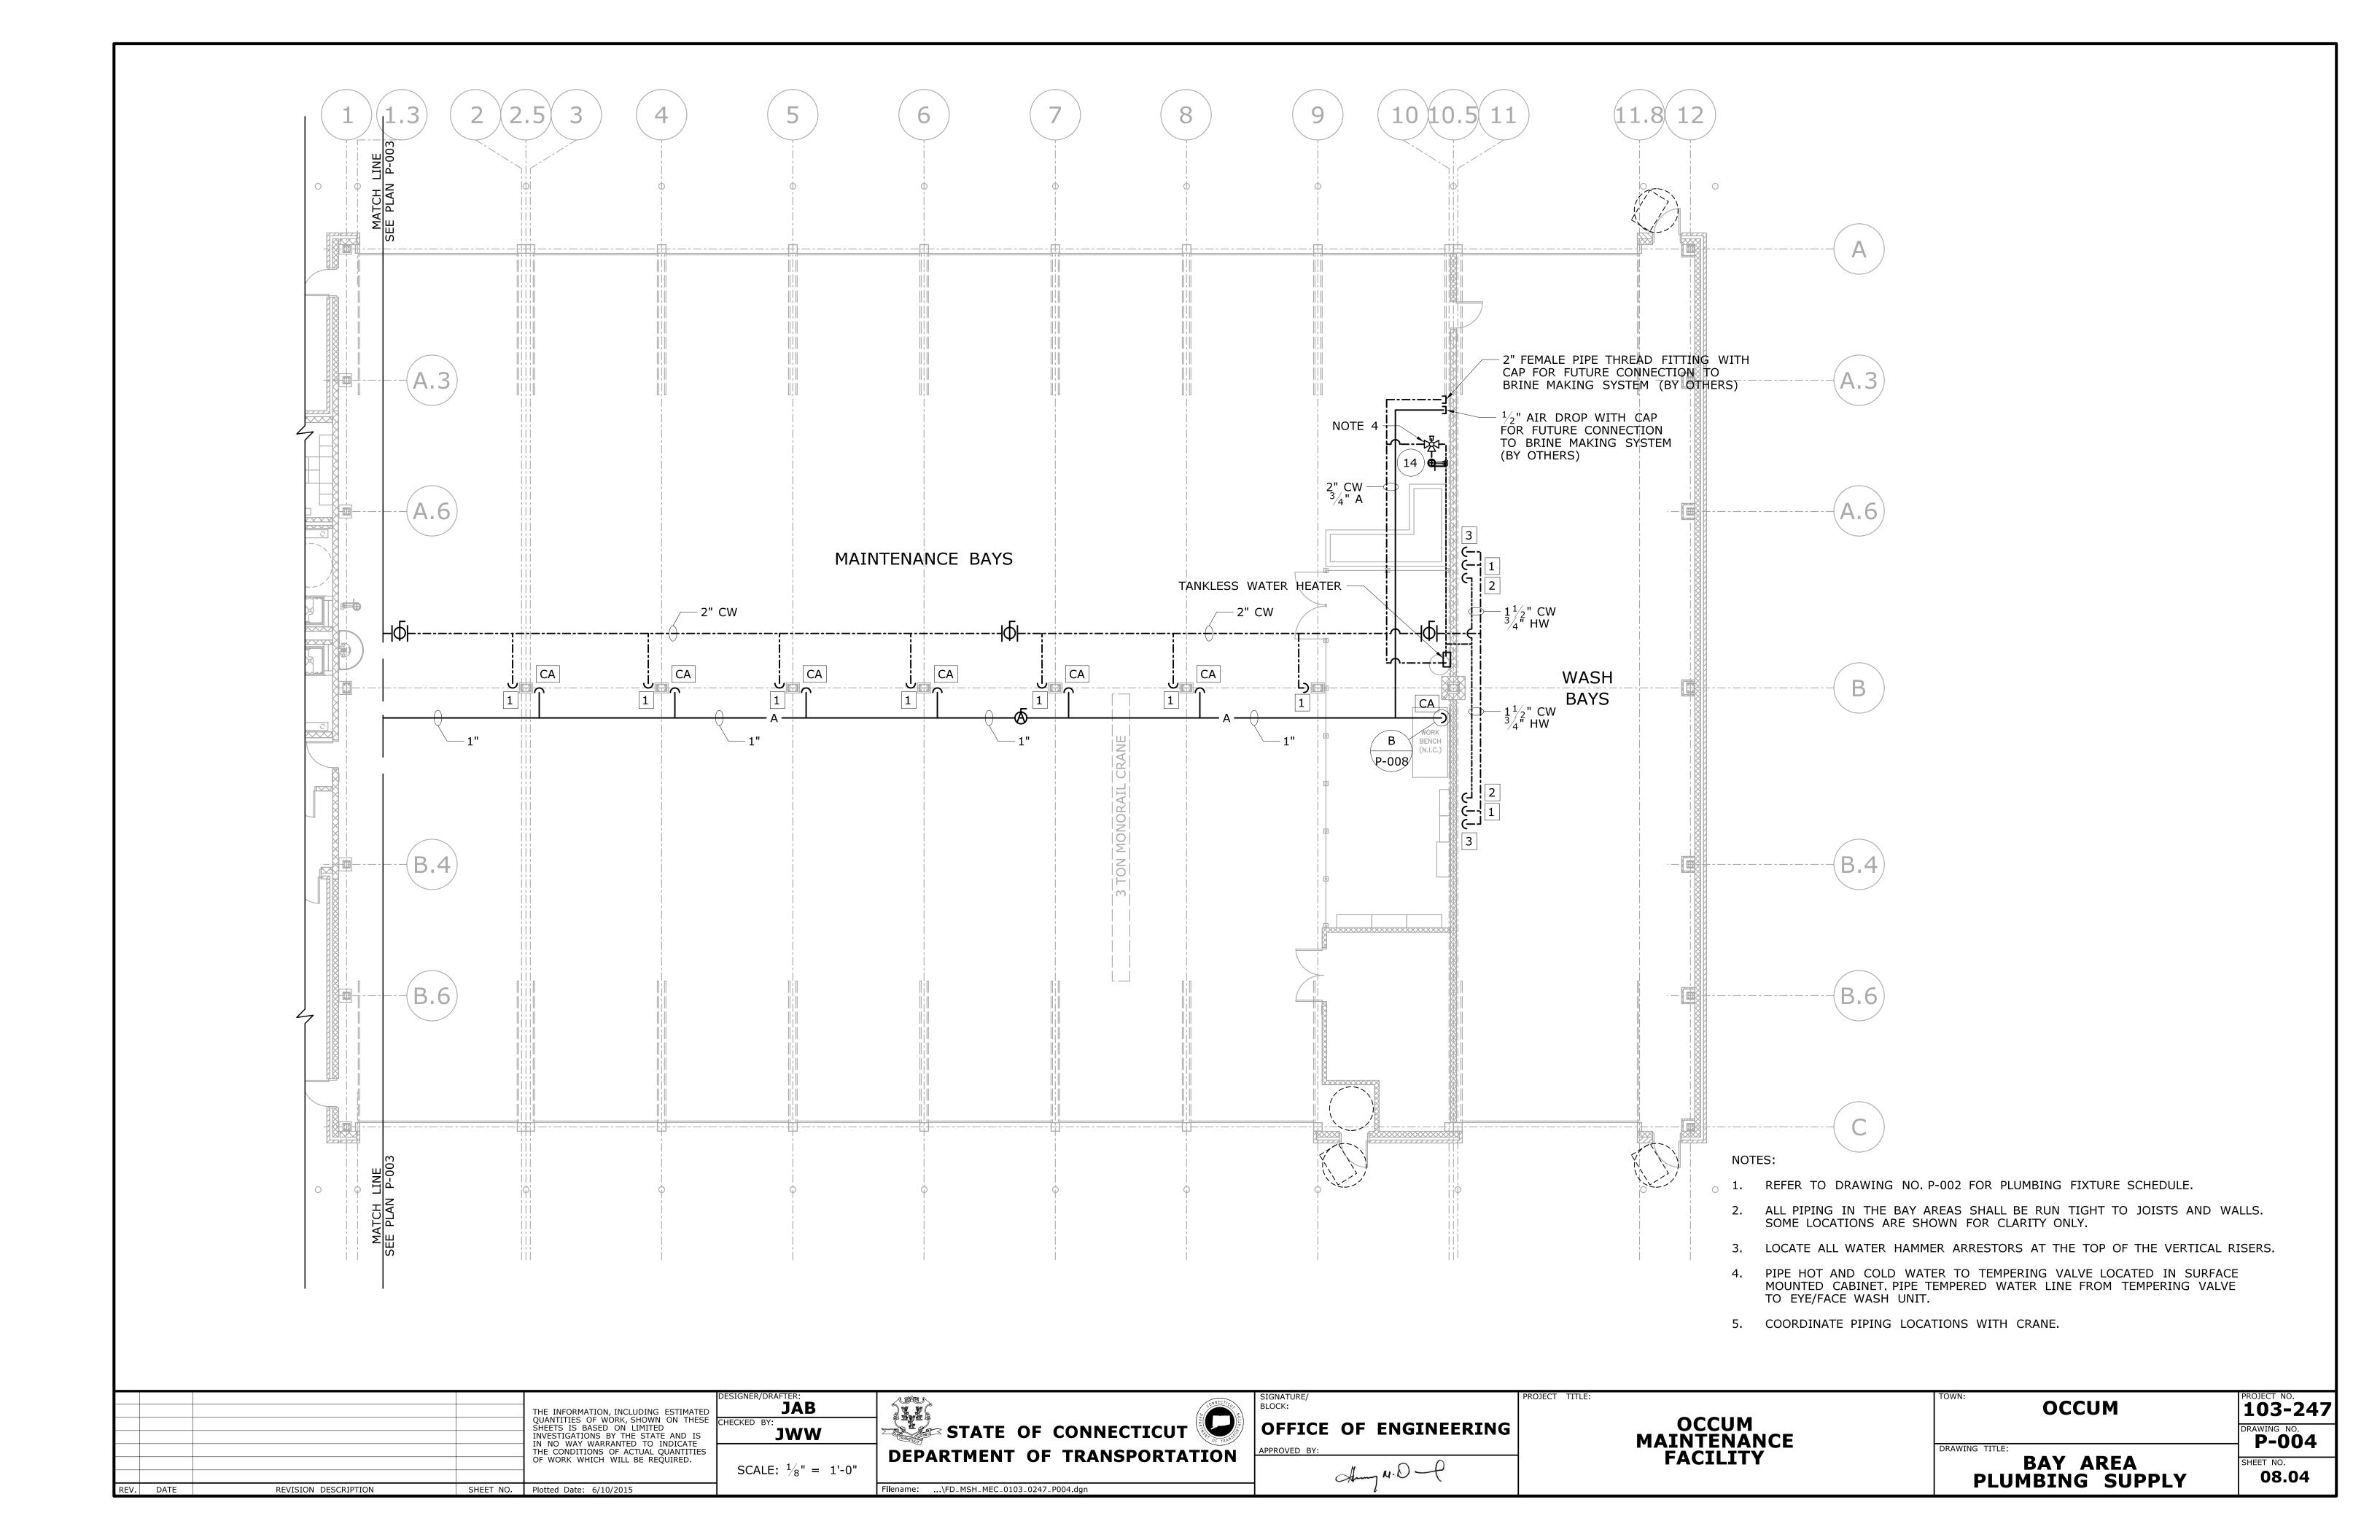
OCCUM MAINTENANCE **FACILITY** 

OCCUM 103-247 P-002 08.02

**LEGEND & GENERAL NOTES** 

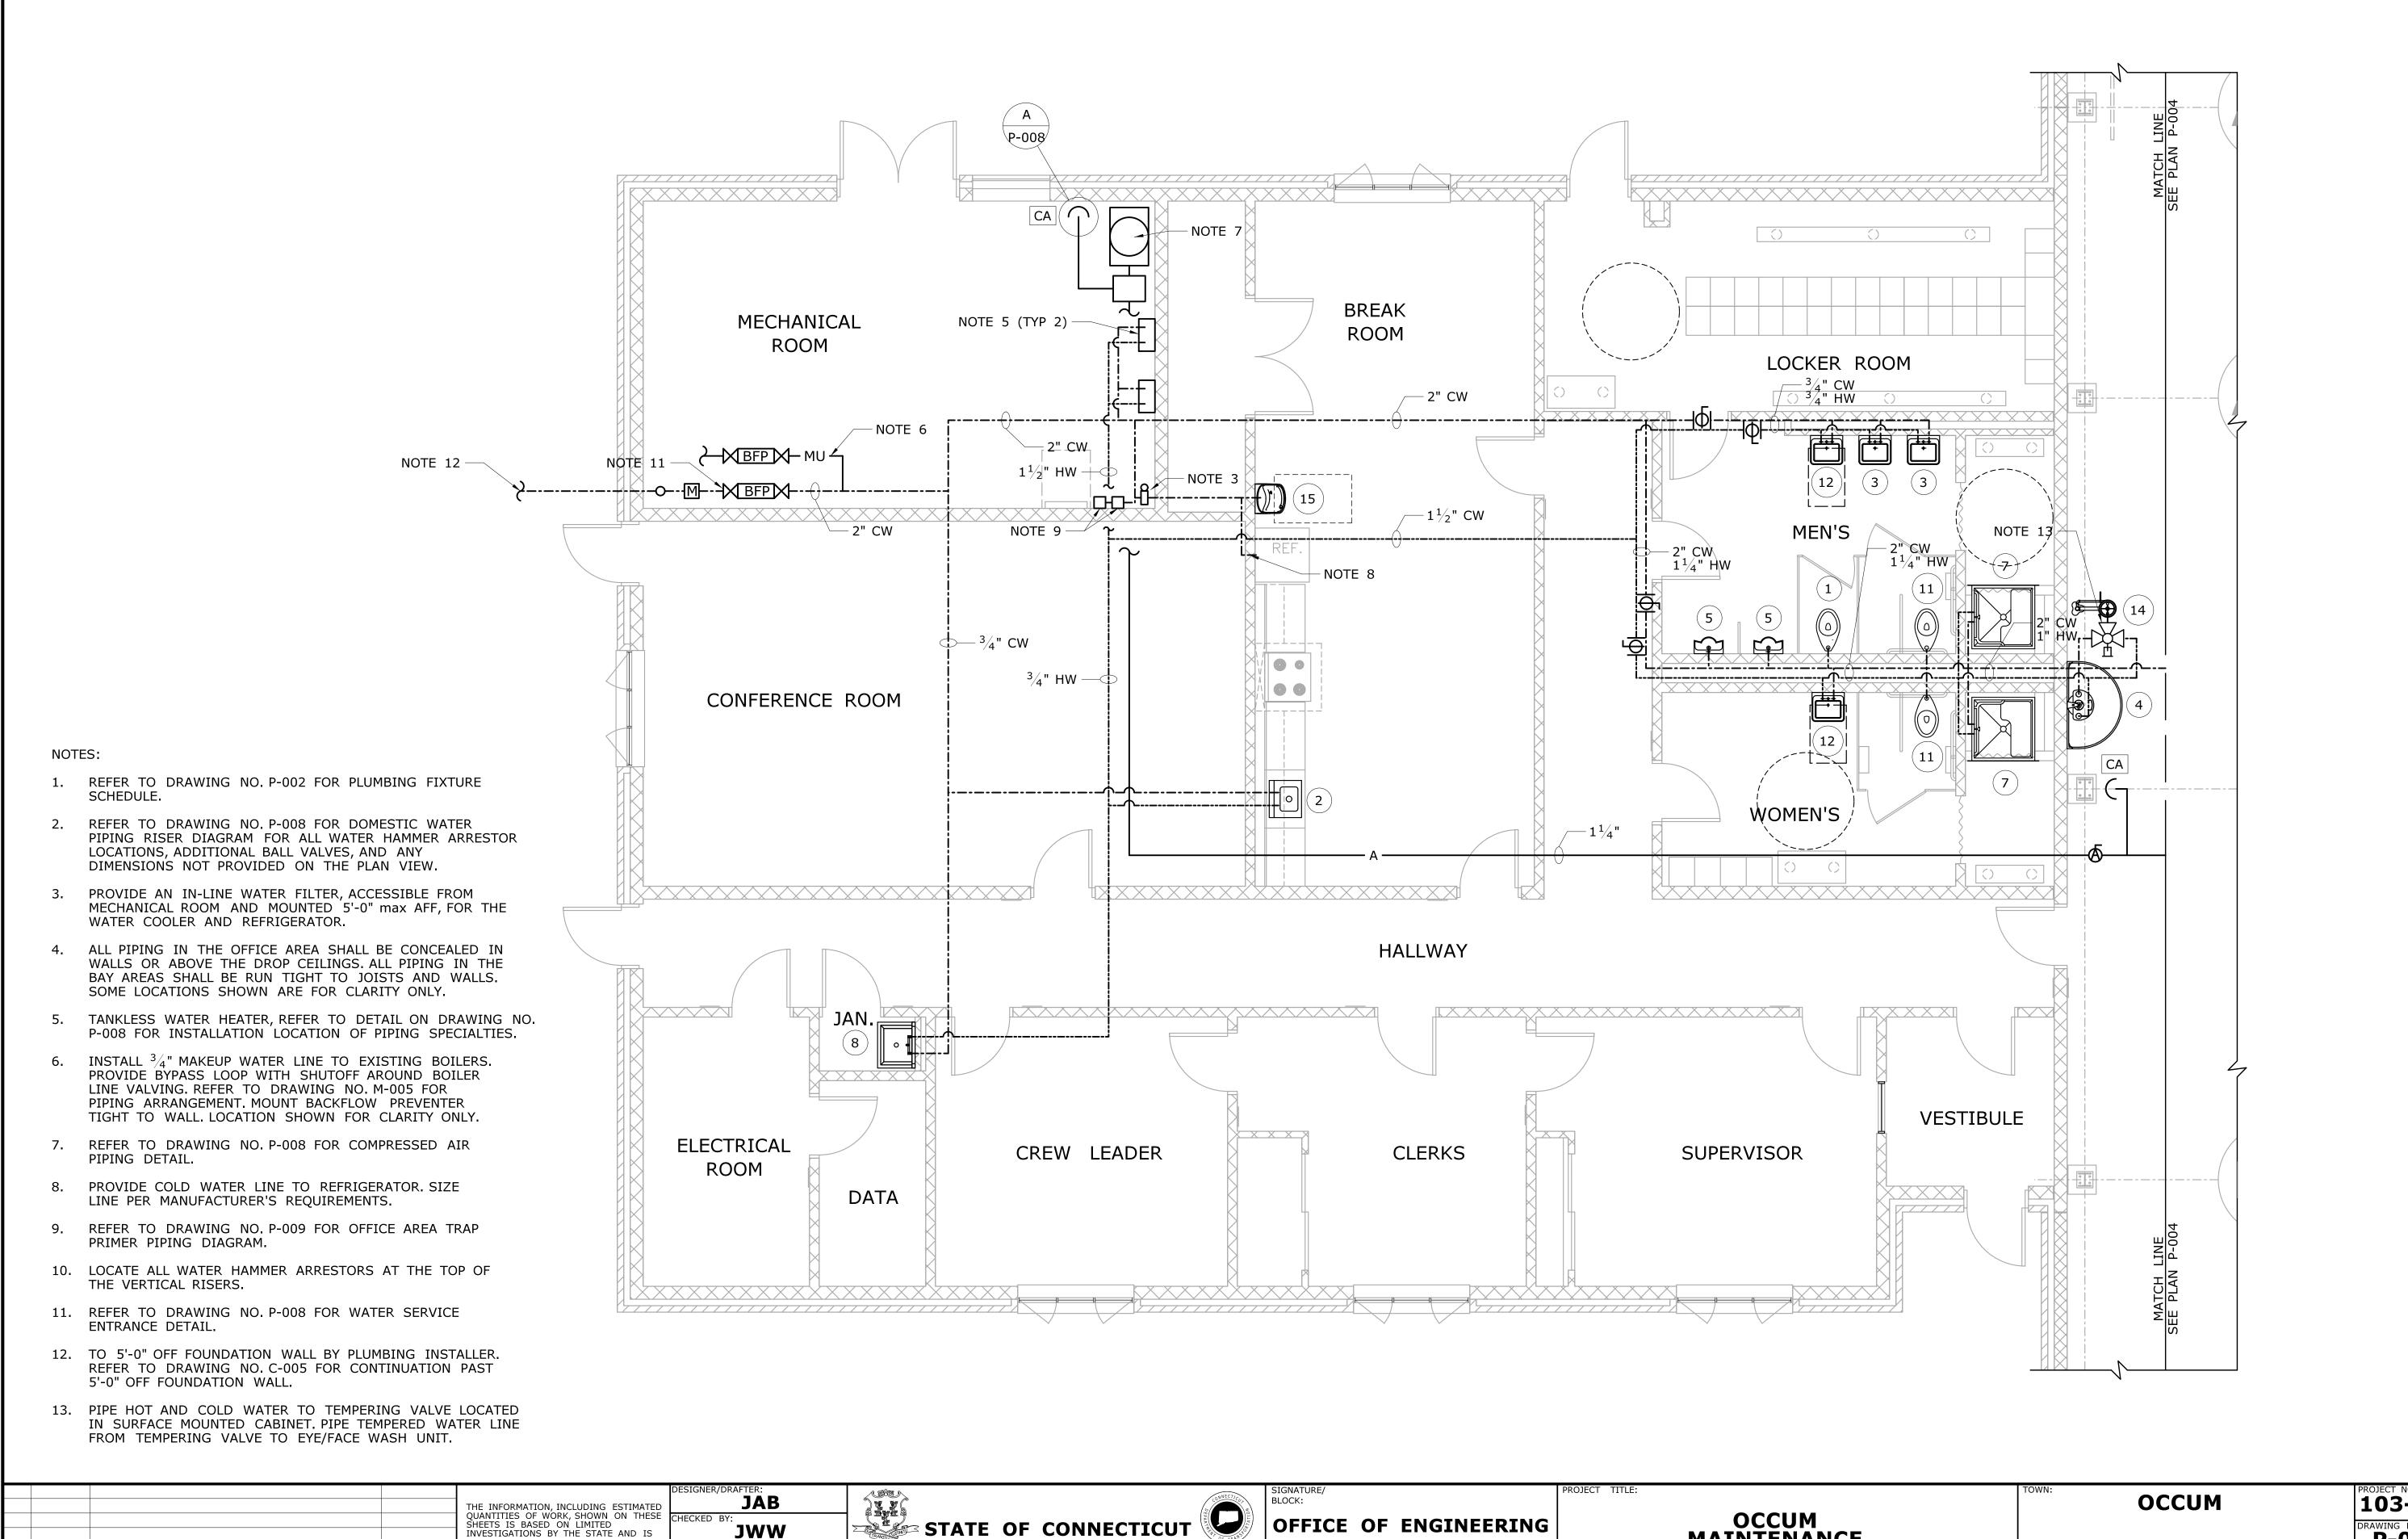


THE INFORMATION, INCLUDING ESTIMATED OUANTITIES OF WORK, SHOWN ON THESE CHI	SIGNER/DRAFTER:  JAB	CONNECTICIA	SIGNATURE/ BLOCK:	PROJECT TITLE:	OCCUM	103-247
SHEETS IS BASED ON LIMITED  INVESTIGATIONS BY THE STATE AND IS IN NO WAY WARRANTED TO INDICATE THE CONDITIONS OF ACTUAL QUANTITIES	JWW	DEPARTMENT OF TRANSPORTATION	OFFICE OF ENGINEERING  APPROVED BY:	MAINTENANCE	DRAWING TITLE:	P-003
OF WORK WHICH WILL BE REQUIRED.	SCALE: $\frac{1}{4}$ " = 1'-0"		Amy N.O.	FACILITY	OFFICE AREA PLUMBING SUPPLY	SHEET NO. <b>08.03</b>
REV. DATE REVISION DESCRIPTION SHEET NO. Plotted Date: 6/10/2015		Filename:\FD_MSH_MEC_0103_0247_P003.dgn	$\iota$		. 231122113 331121	





### NOTES:


- 1. REFER TO DRAWING NO. P-002 FOR PLUMBING FIXTURE SCHEDULE.
- 2. REFER TO DRAWING NO. P-009 FOR SANITARY PIPING RISER DIAGRAM FOR ANY DIMENSIONS NOT PROVIDED ON THE PLAN VIEW.
- 3. ALL PIPING IN THE OFFICE AREA SHALL BE CONCEALED IN WALLS OR ABOVE THE DROP CEILINGS. SOME LOCATIONS SHOWN ARE FOR CLARITY ONLY.
- 4. REFER TO DRAWING NO. P-009 FOR OFFICE AREA TRAP PRIMER PIPING DIAGRAM.

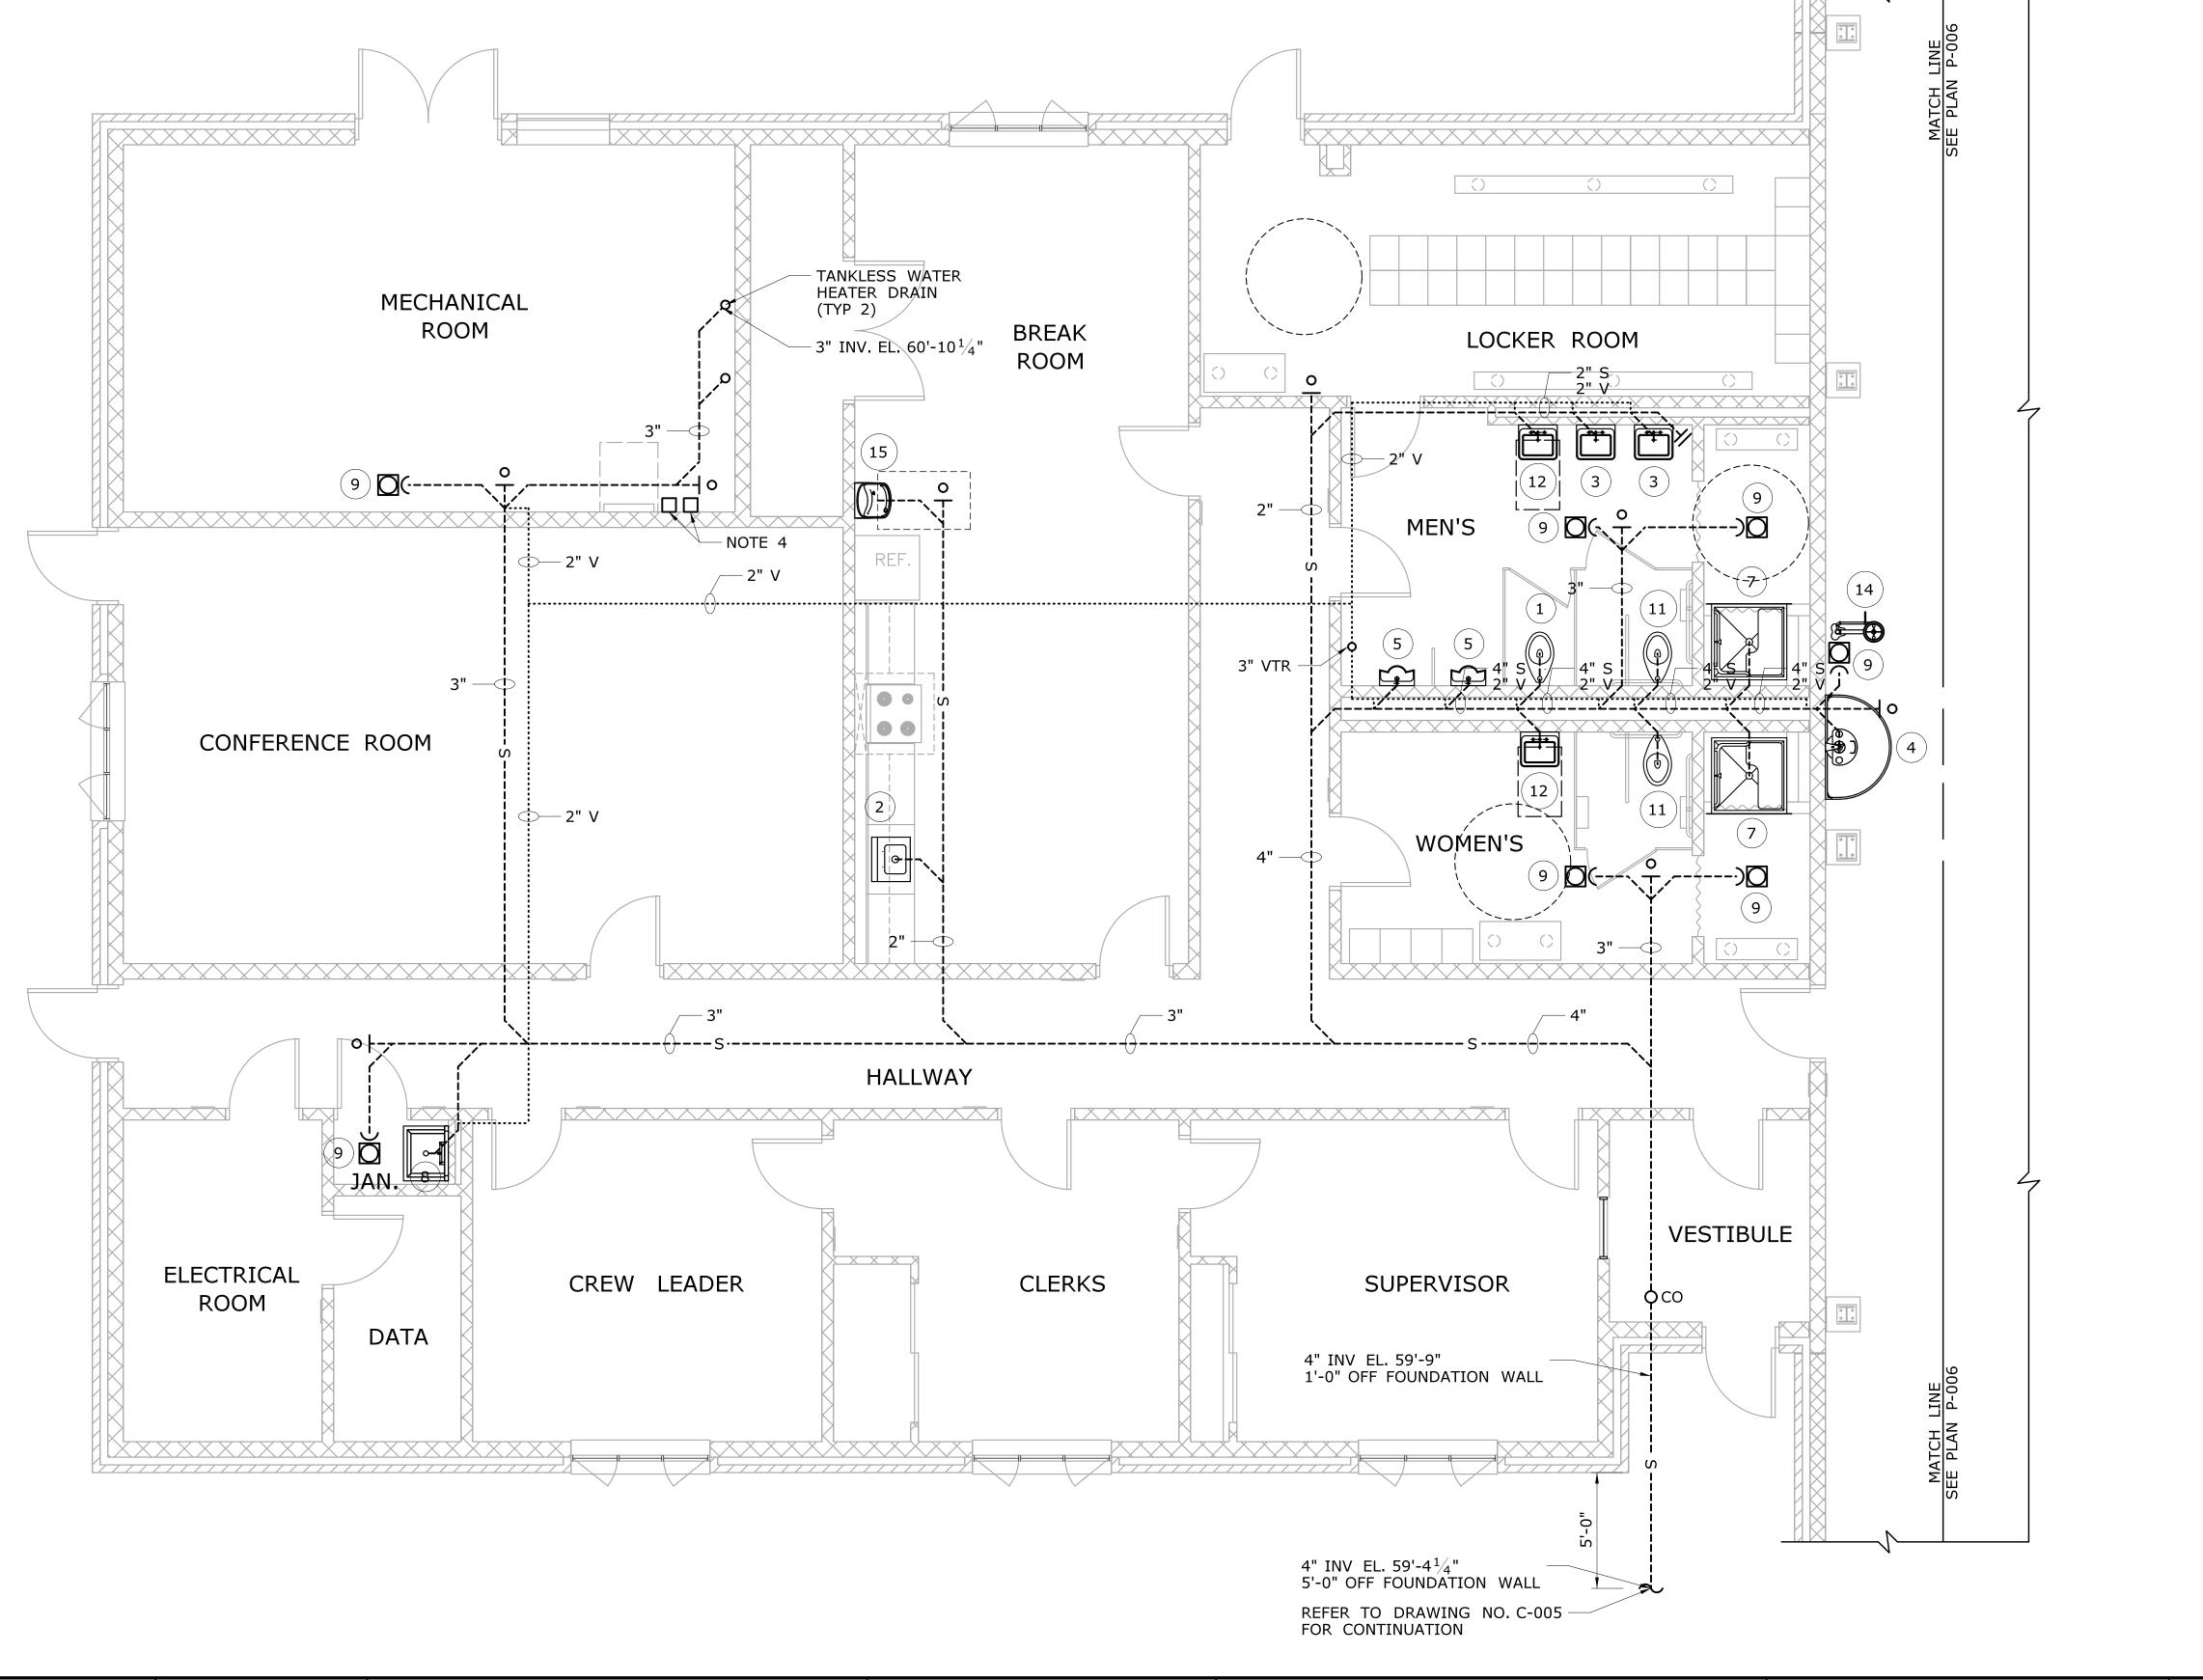



			THE INFORMATION, INCLUDING ESTIMATED QUANTITIES OF WORK, SHOWN ON THESE	D IS CATE TITIES  TIMW	STATE OF CONNECTICUT DEPARTMENT OF TRANSPORTATION	SIGNATURE/ BLOCK:  OFFICE OF ENGINEERING  APPROVED BY:	PROJECT TITLE:  OCCUM	OCCUM	PROJECT NO. <b>103-2</b> 4
			SHEETS IS BASED ON LIMITED INVESTIGATIONS BY THE STATE AND IS IN NO WAY WARRANTED TO INDICATE THE CONDITIONS OF ACTUAL QUANTITIES OF WORK WHICH WILL BE REQUIRED.				MAINTENANCE FACILITY	OFFICE AREA	DRAWING NO. P-005  SHEET NO. 08.05
EV. DATE	REVISION DESCRIPTION	SHEET NO.	Plotted Date: 6/10/2015	1	Filename:\FD_MSH_MEC_0103_0247_P005.dgn			PLUMBING DRAINAGE	08.0

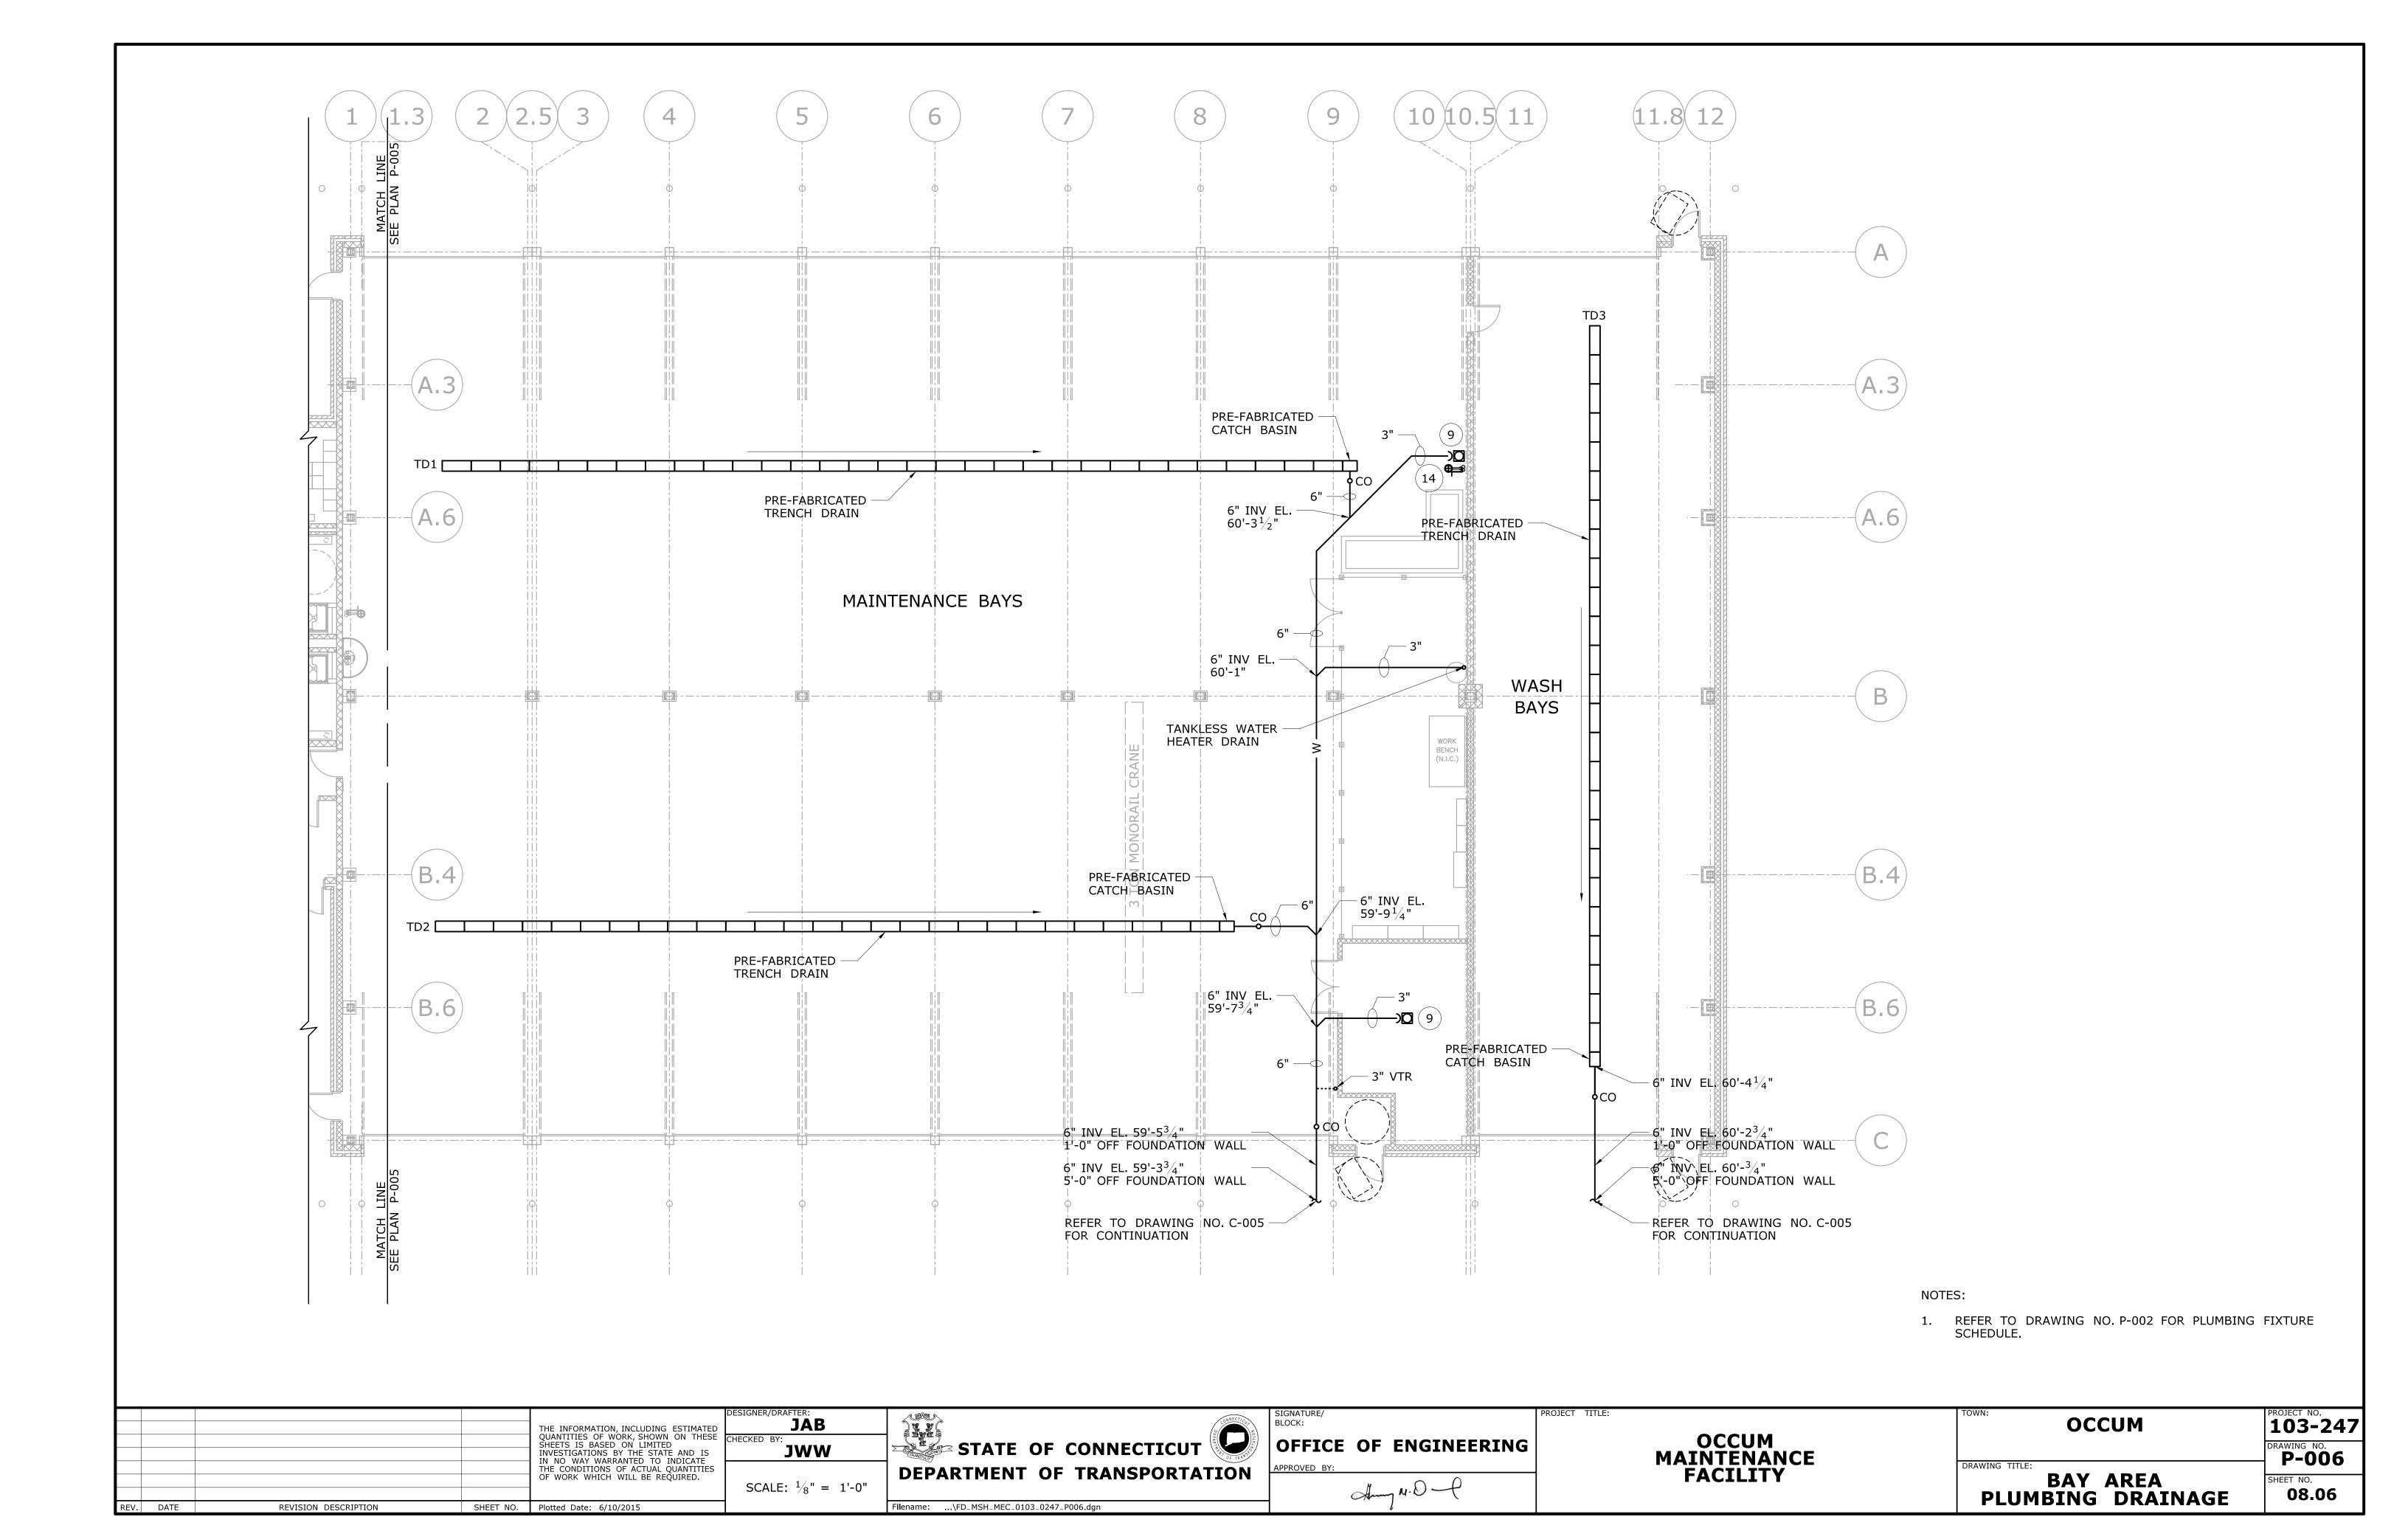

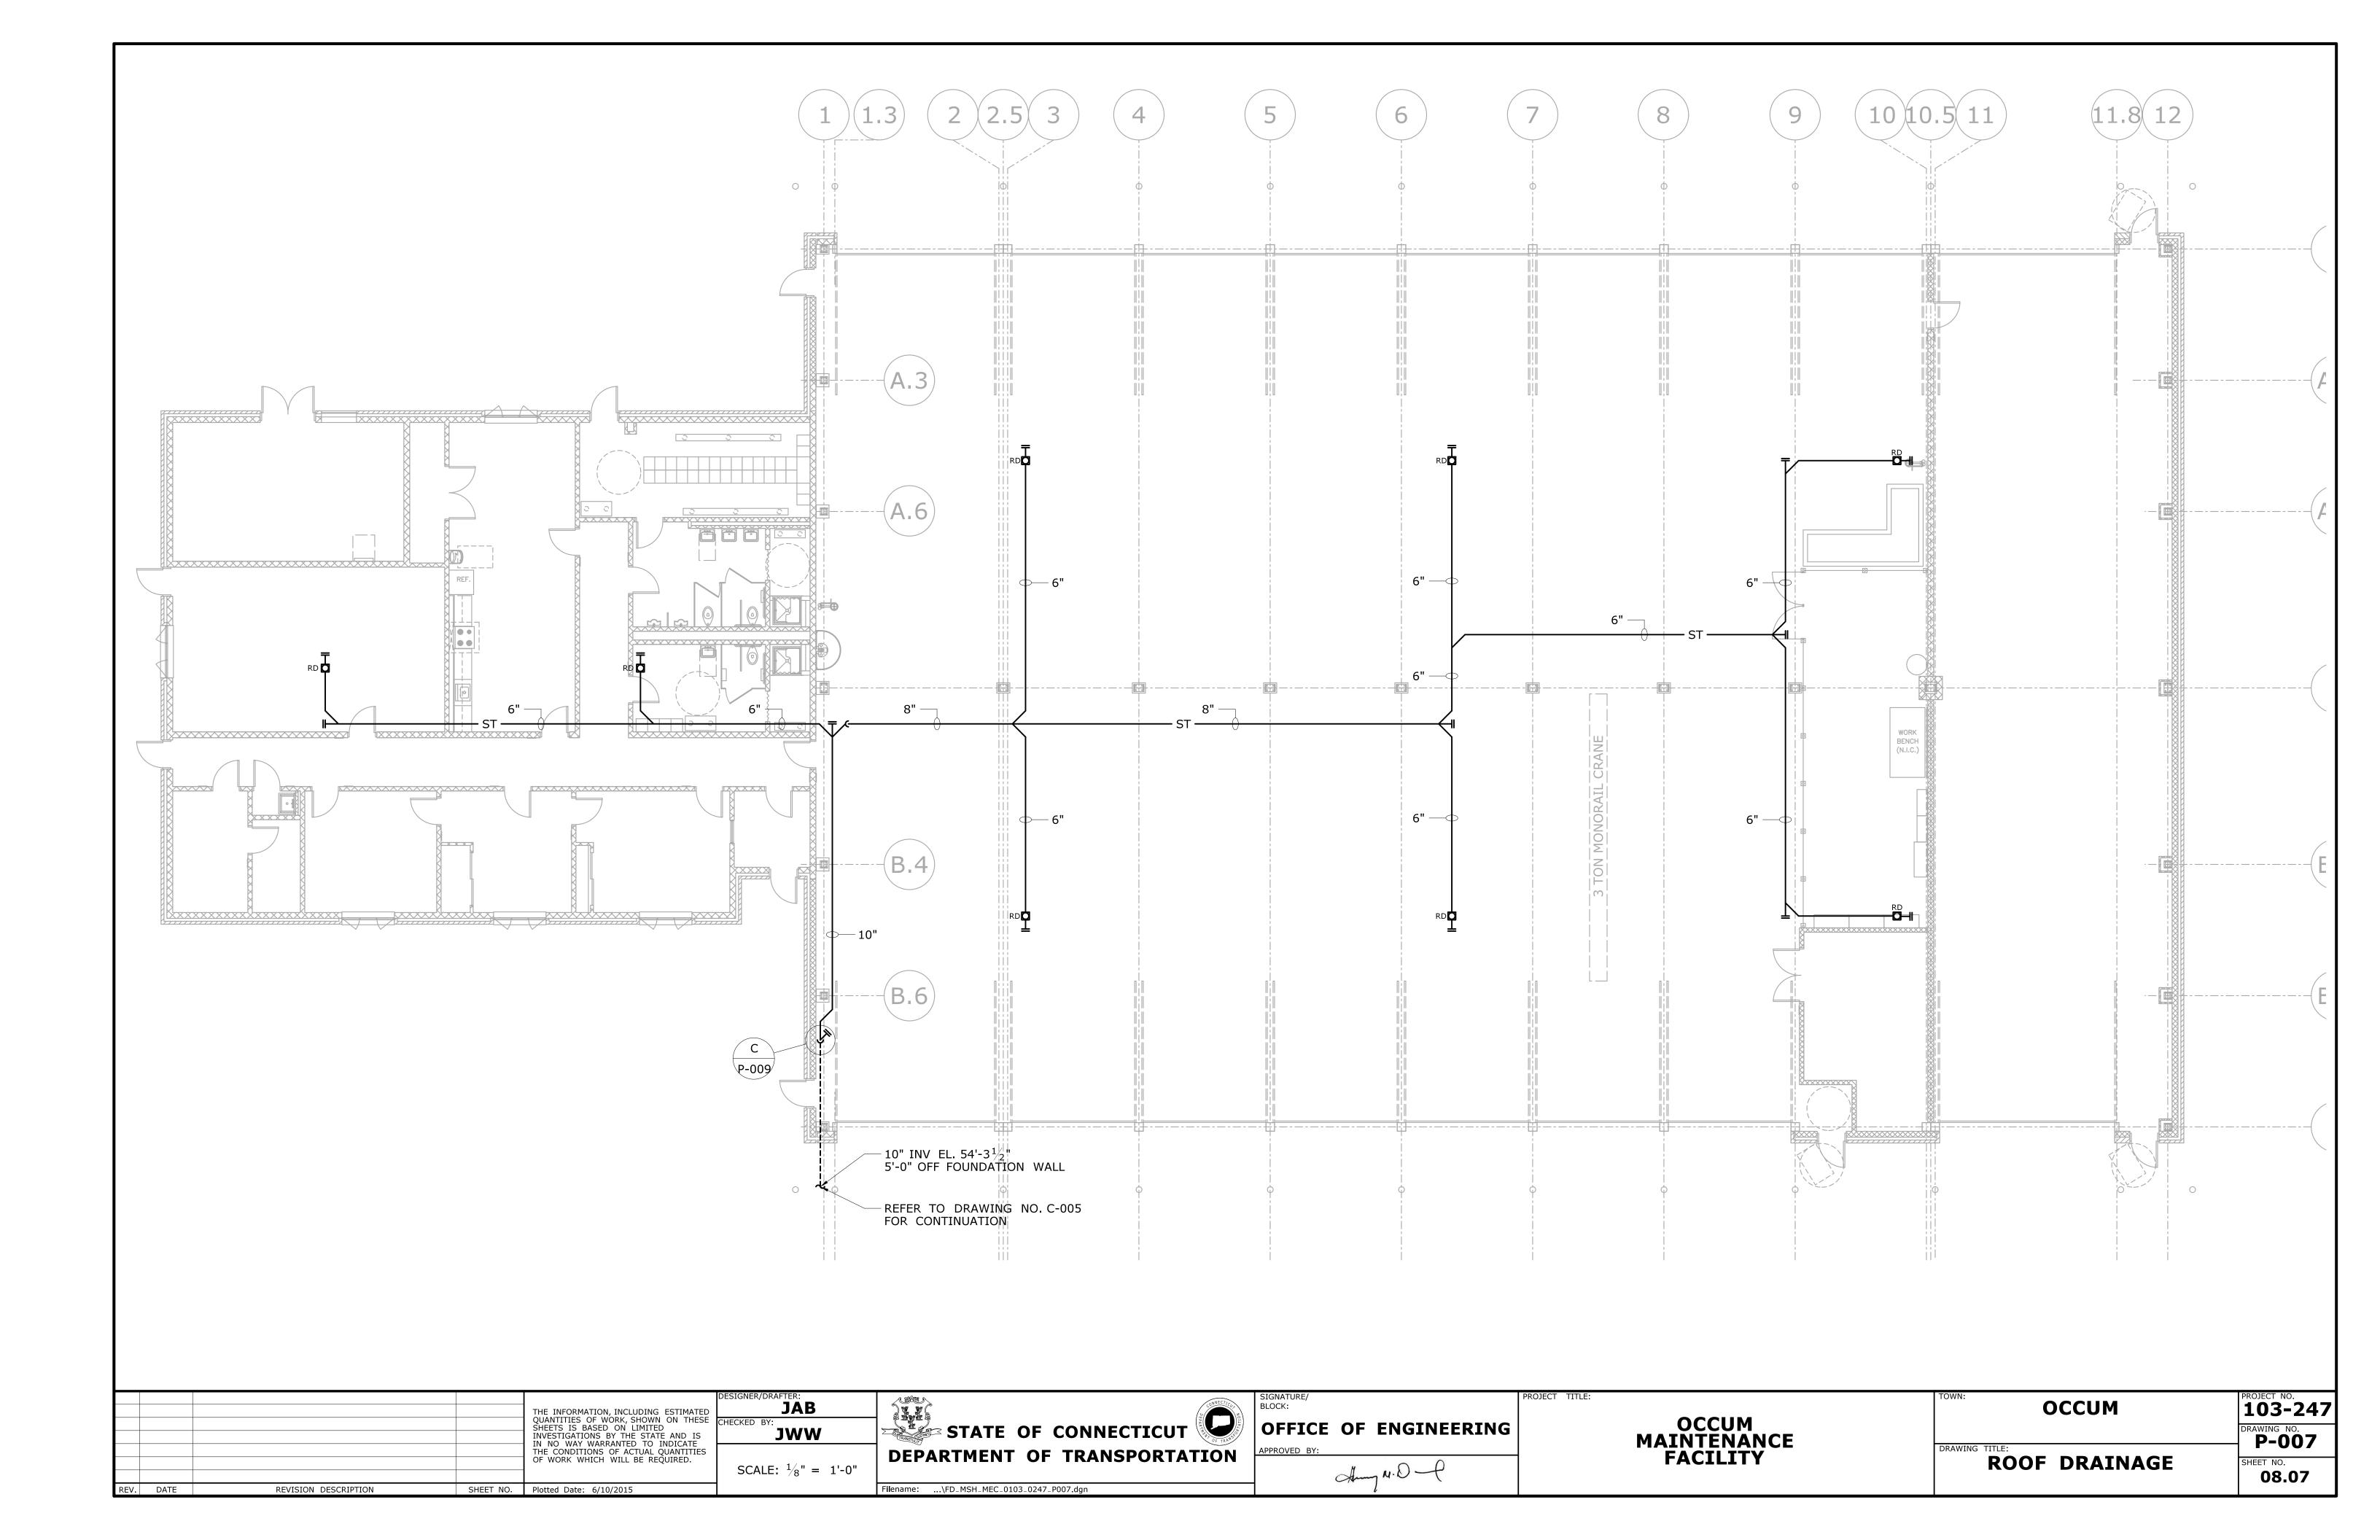

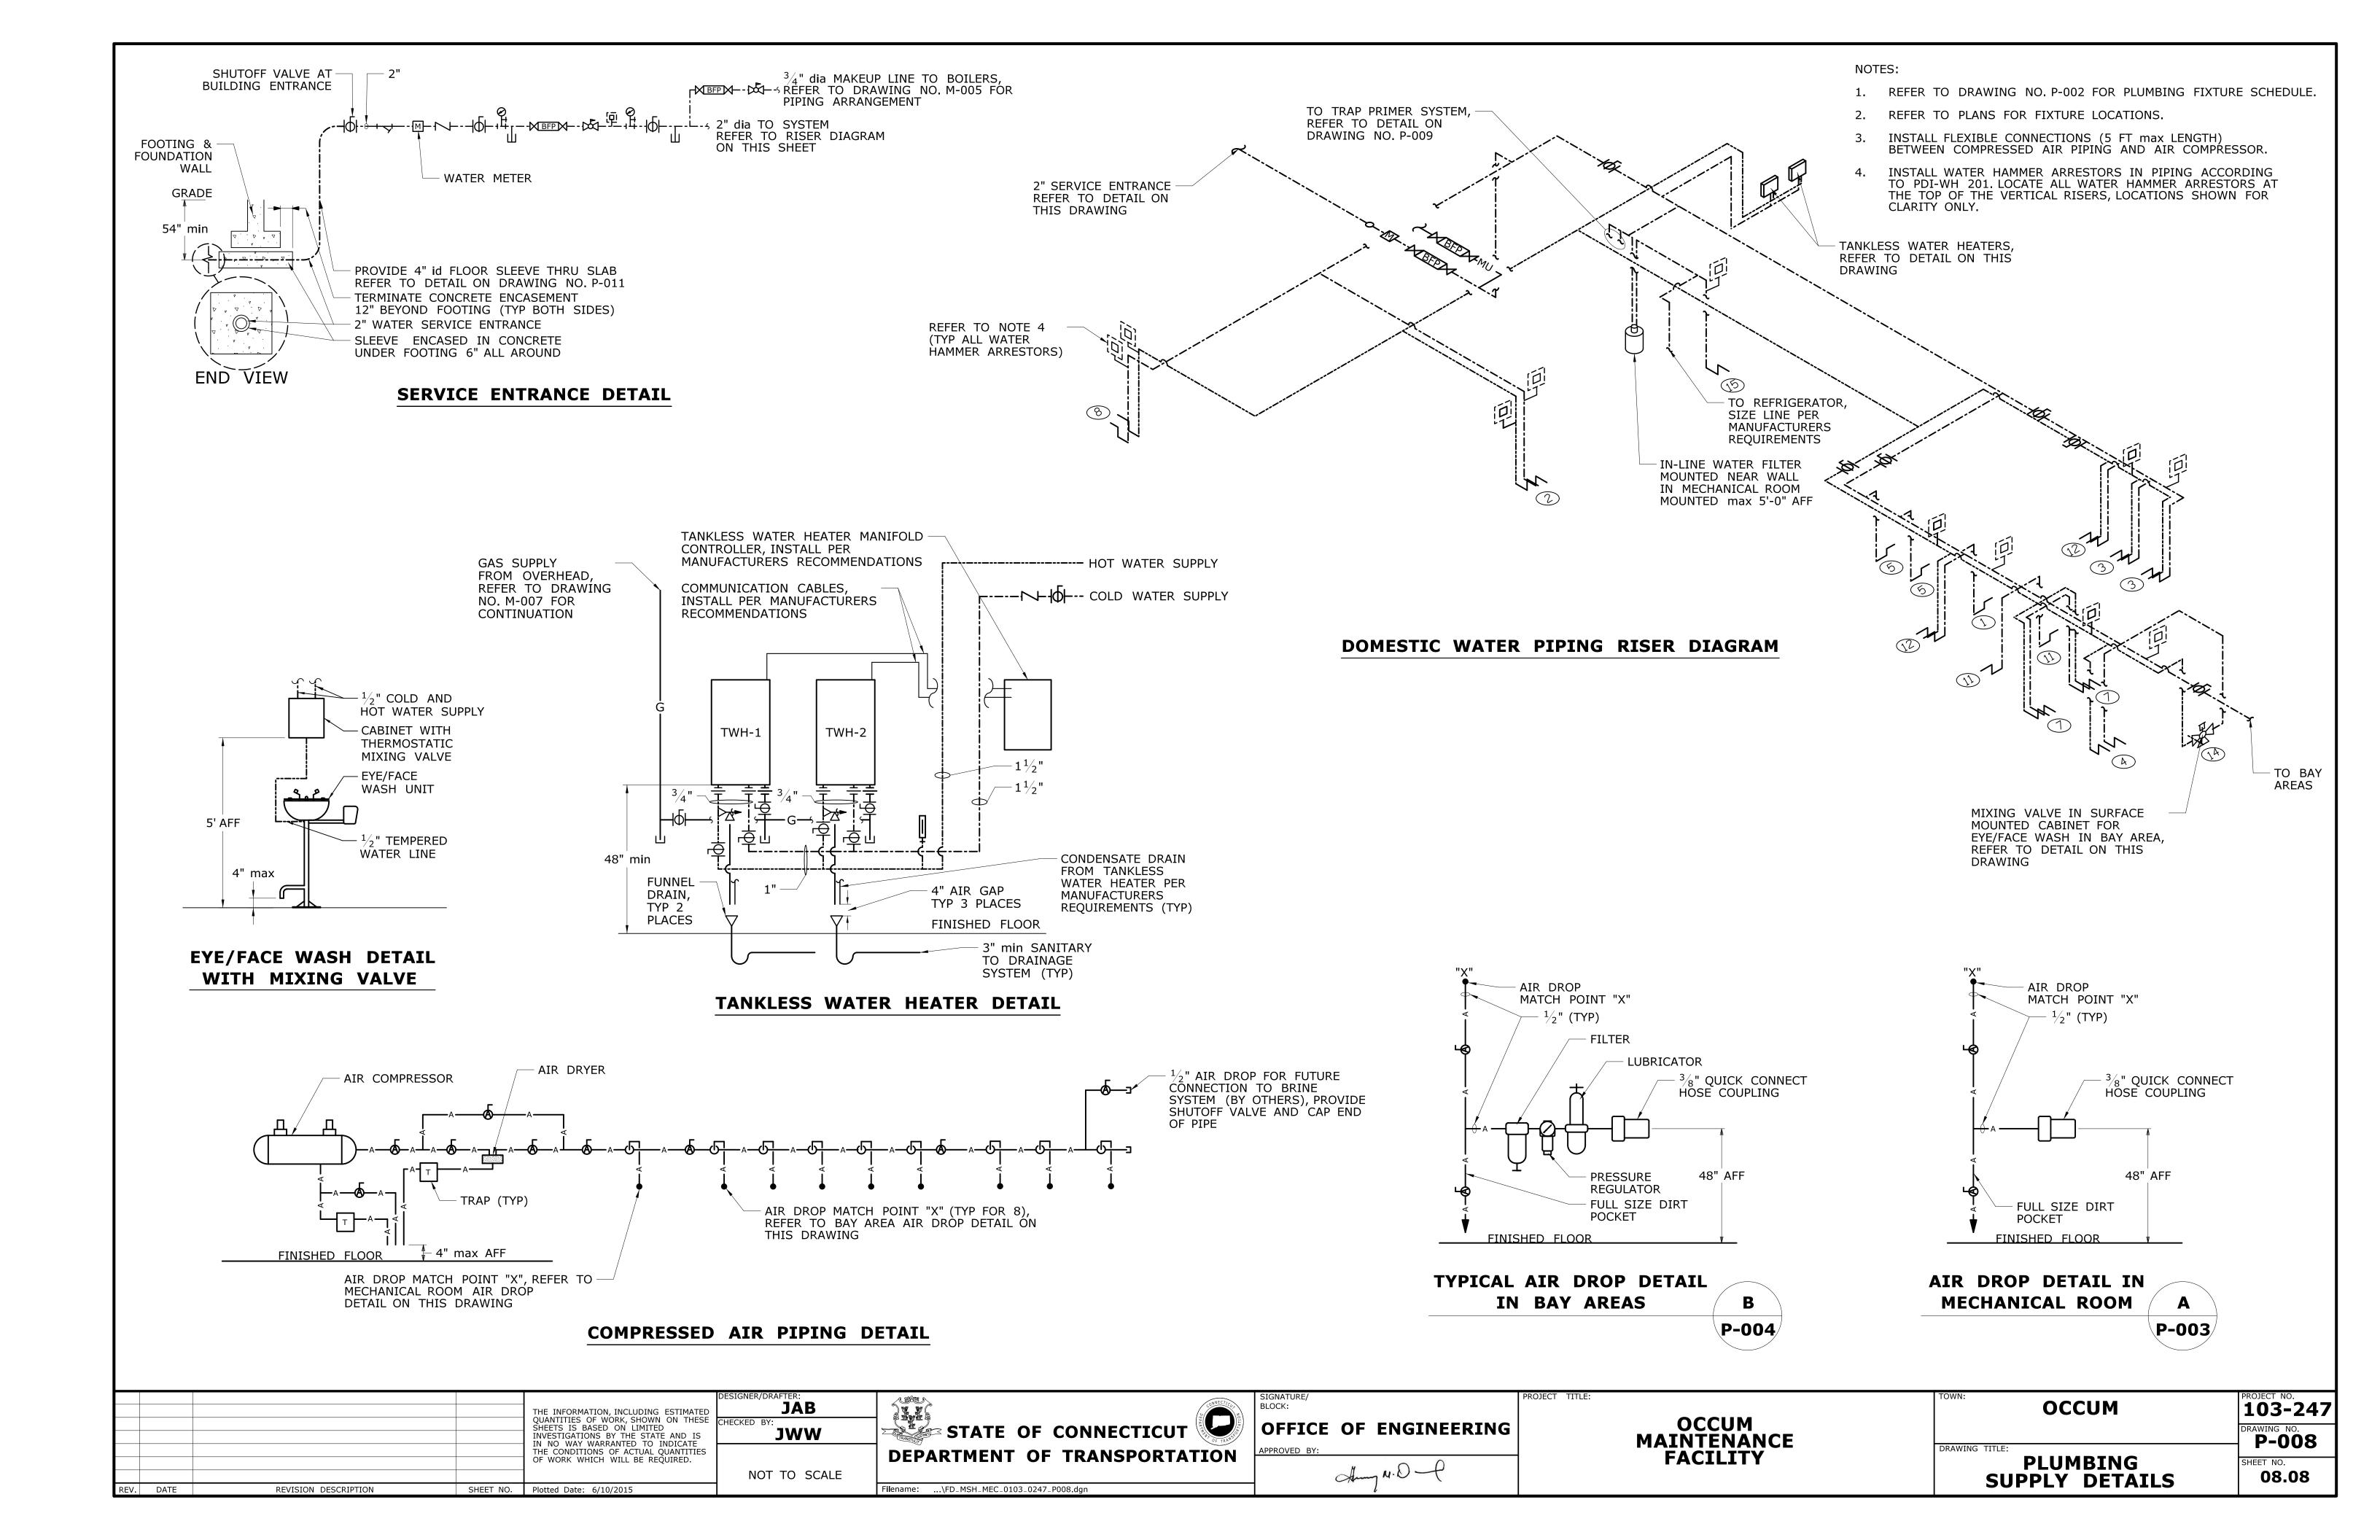

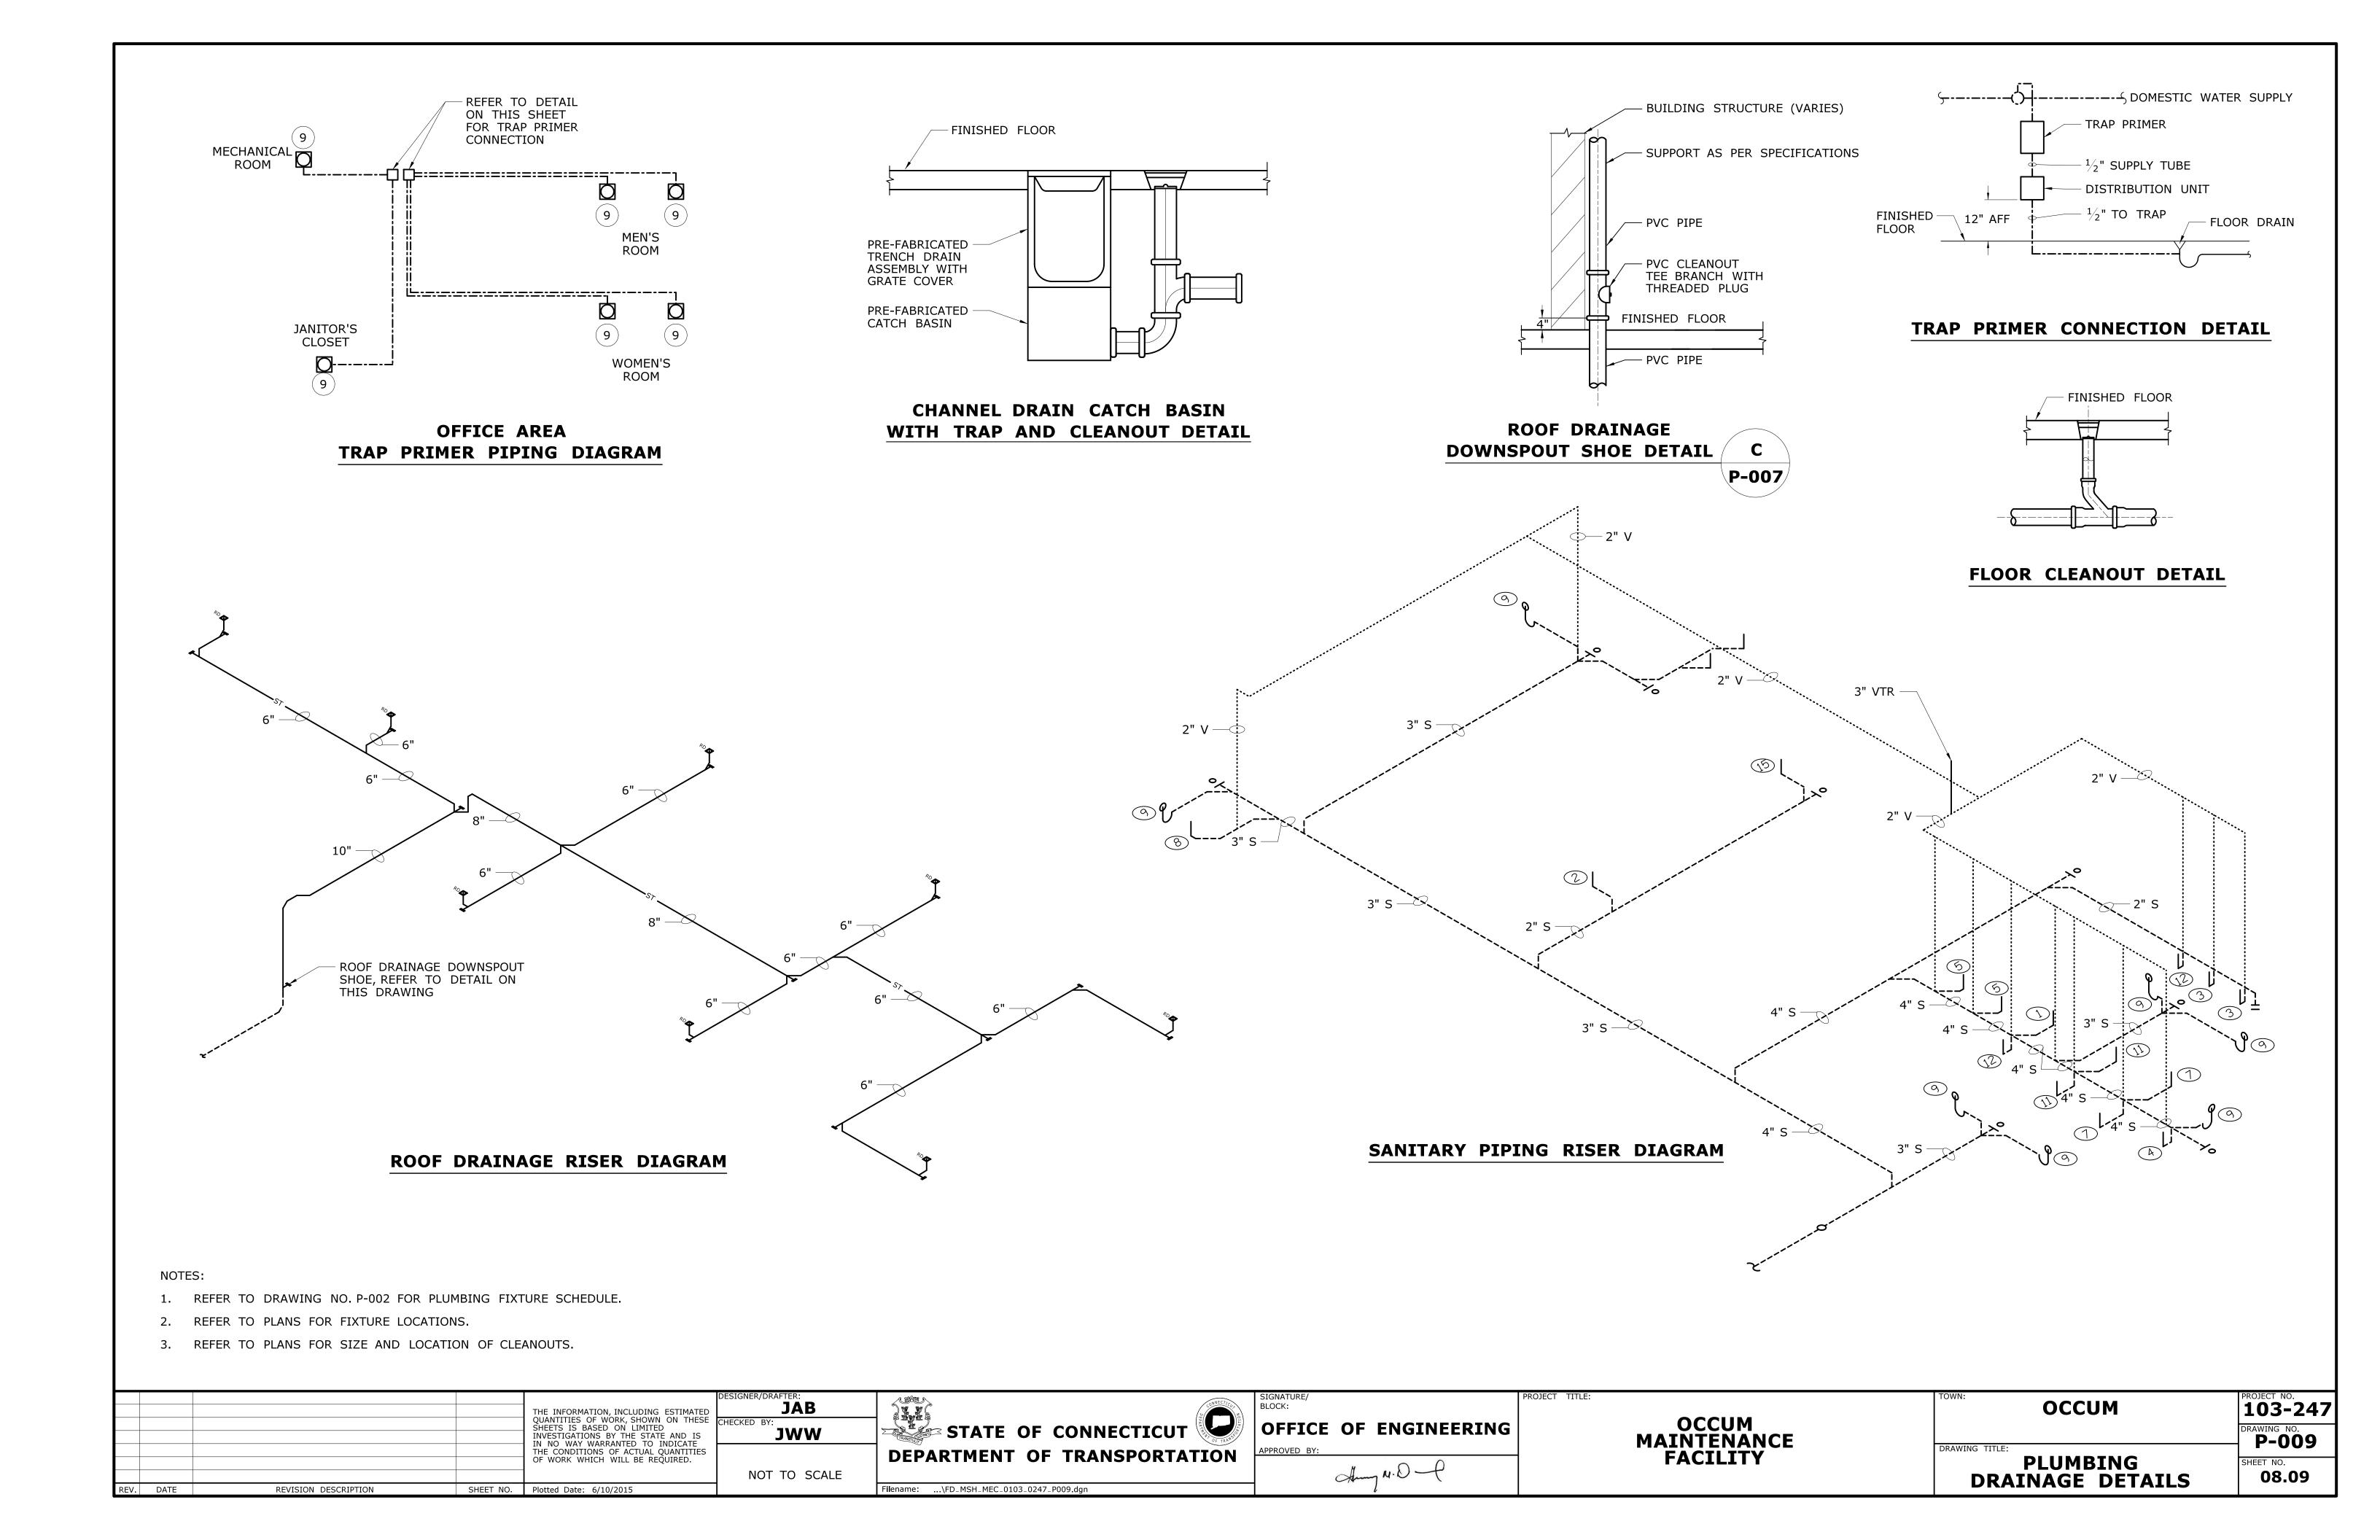

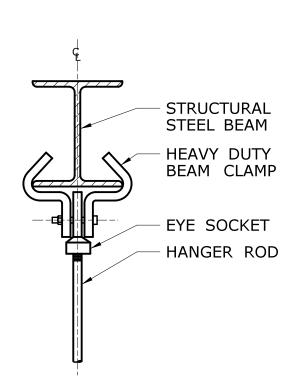

CENTER BEAM CLAMP WITH EYE NUT
TYPE ATTACHMENT TO STEEL BEAM

HANGER NUT

OF OWSJ

**ATTACHMENT TO** 

**OPEN WEB STEEL JOISTS** 

BOTTOM CHORD

BENT STRAP "-"  $1 \cdot \frac{1}{2}$ " x  $\frac{3}{16}$ " OVER VERT LEGS OF ANGLES


WEB MEMBERS -

ONE ANGLE EACH SIDE OF WEB MEMBERS REST ON TOP

OF BOTTOM CHORD OR OWSJ


BETWEEN PANEL POINTS

WELDS

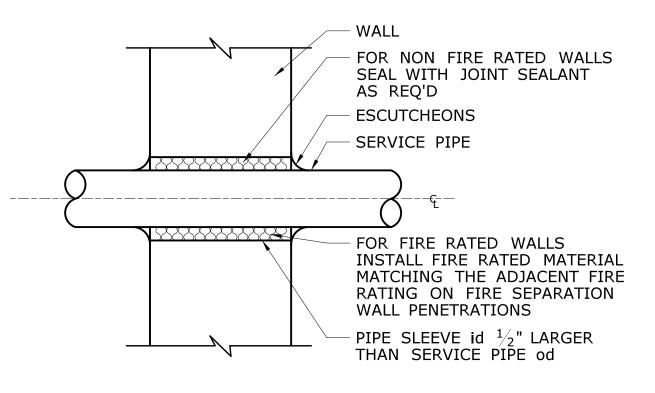


NOTE: SEAL ALL PENETRATIONS AS PER SPECIFICATIONS.

# INTERIOR WALL SLEEVE DETAIL

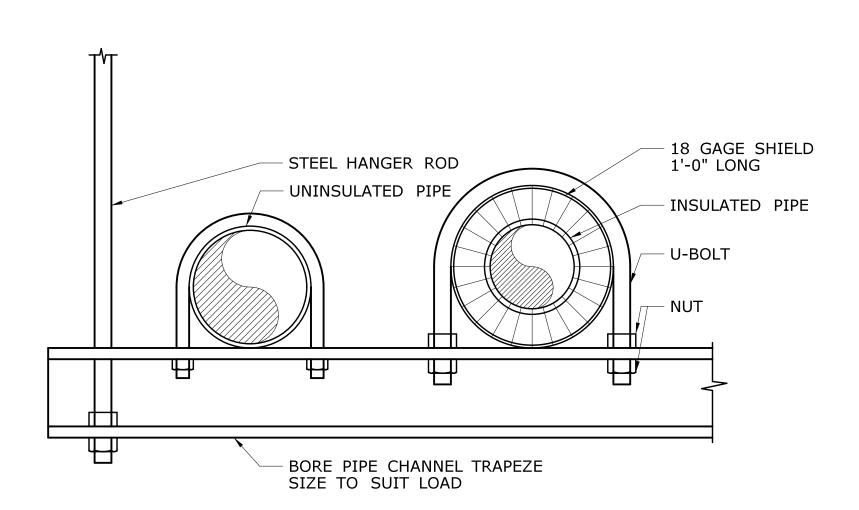


TRAPEZE PIPE SUPPORT

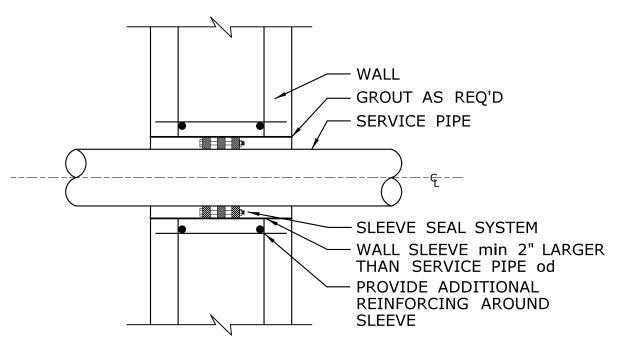



NOTE: SEAL ALL PENETRATIONS AS PER SPECIFICATIONS. SUGGESTED SLEEVE SIZES ARE MINIMUM AND SHALL BE SIZED PER SLEEVE SEAL MANUFACTURER'S INSTRUCTIONS WHERE REQUIRED.


# EXTERIOR WALL SLEEVE DETAIL

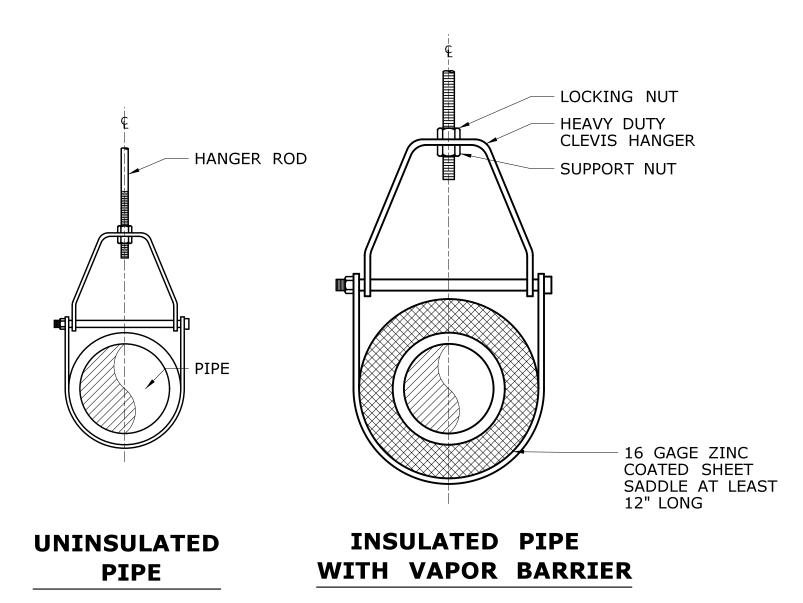

ADJUSTABLE STEEL CLEVIS HANGER

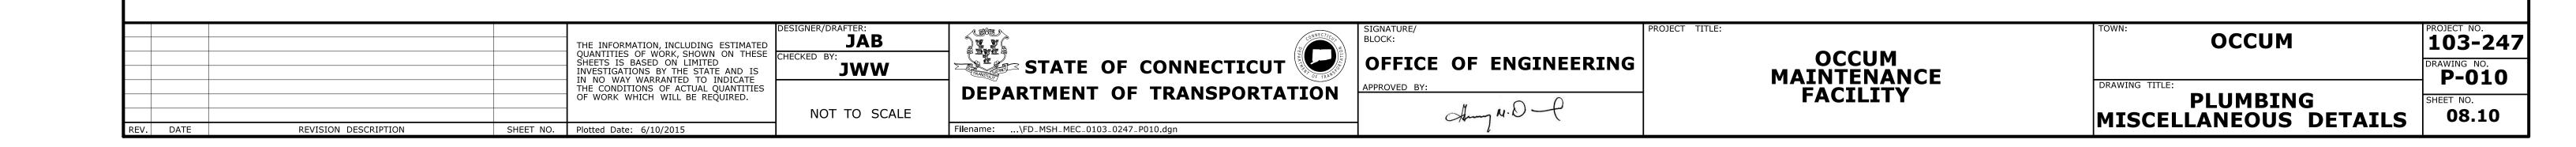

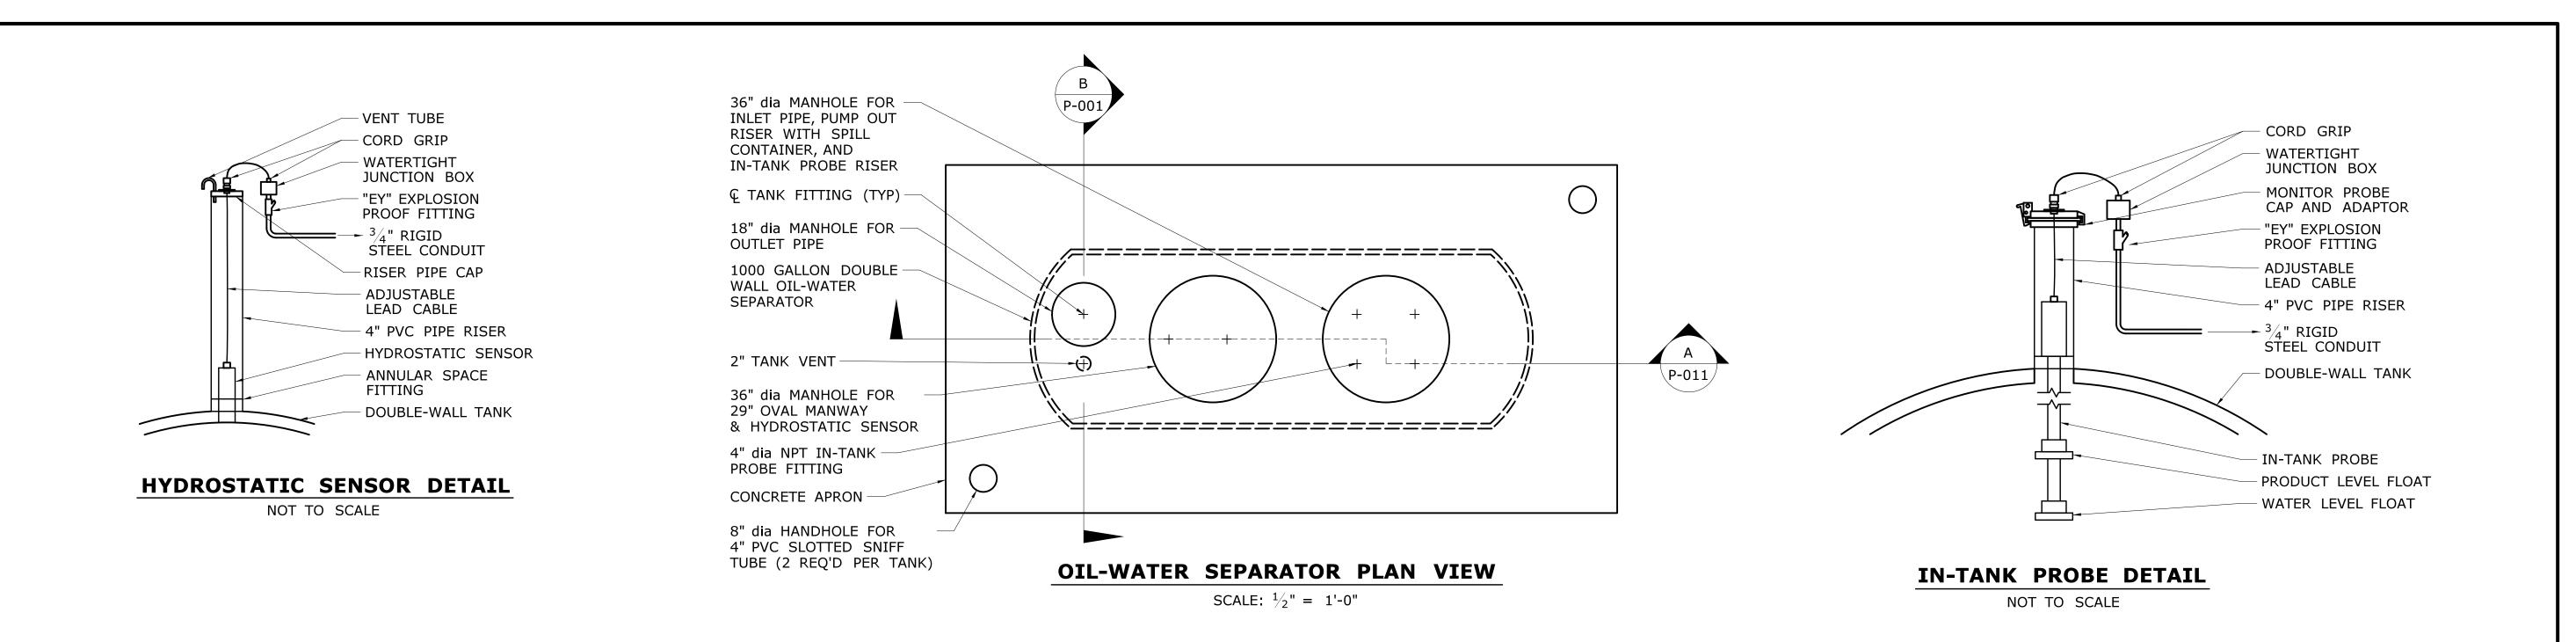

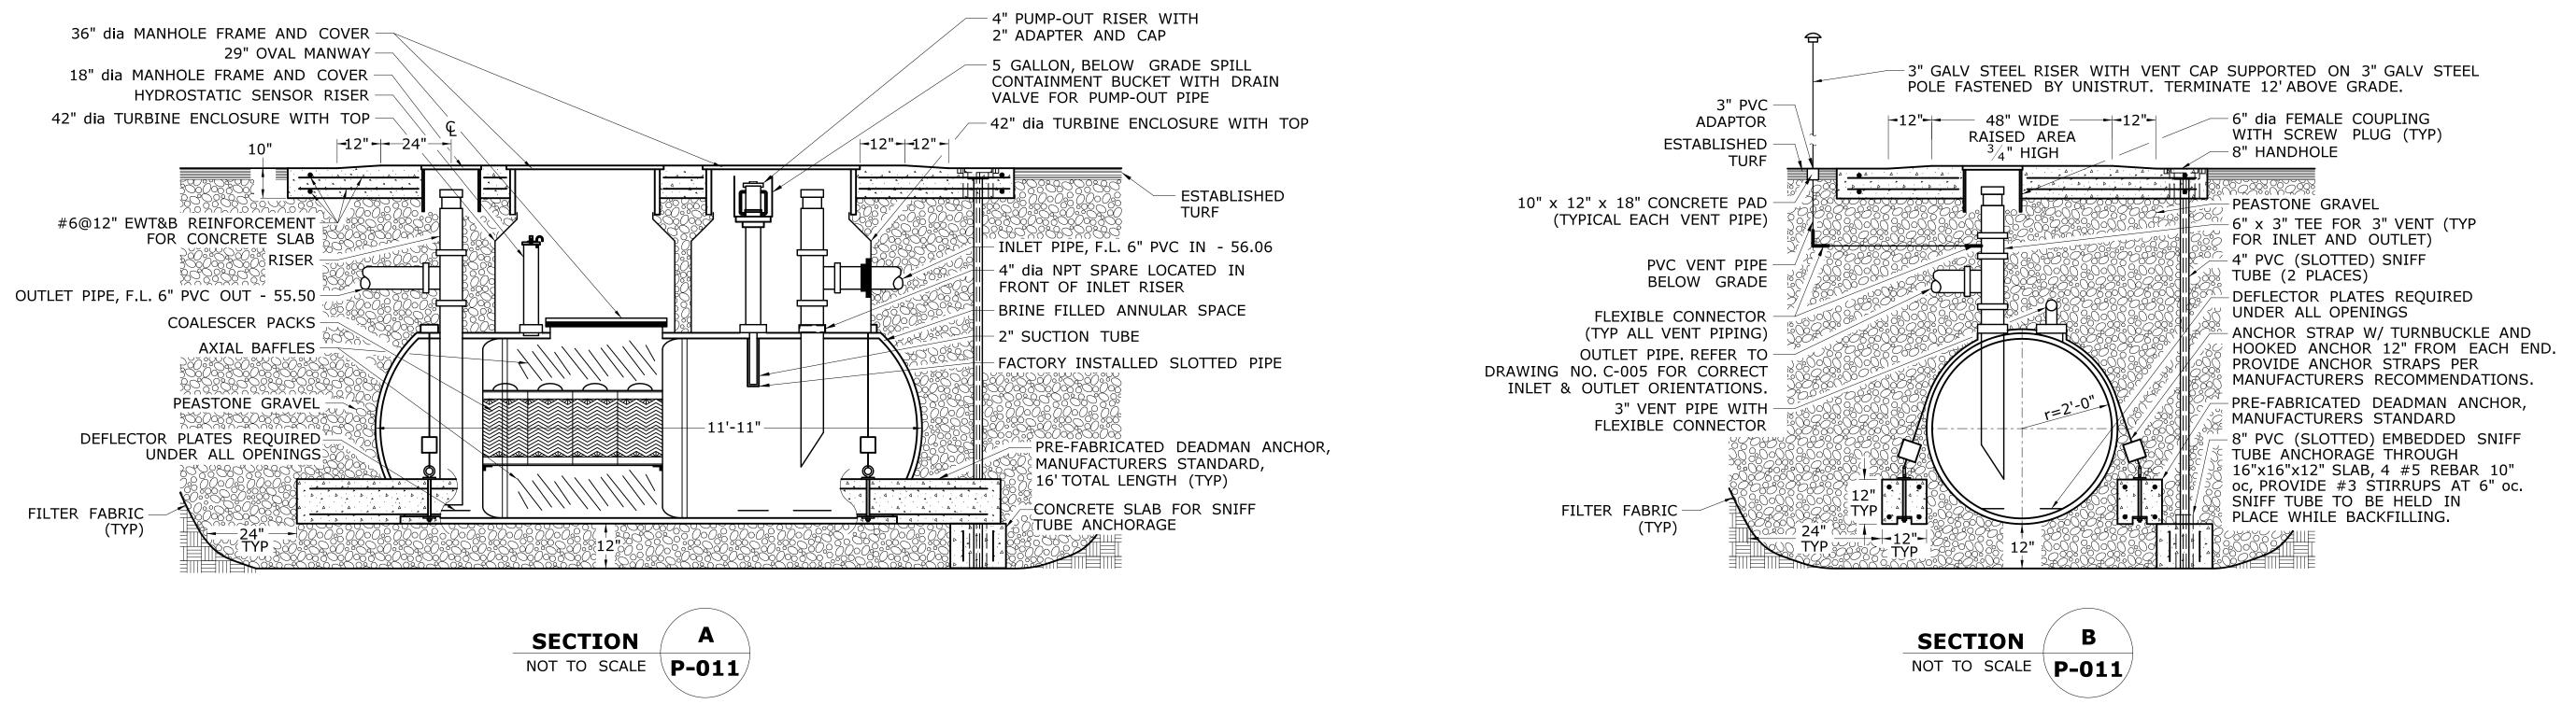

## NOTES:

- 1. THE DESIGNED TANK DIMENSIONS ARE BASED ON CONTAINMENT SOLUTIONS. ACTUAL PAD DIMENSIONS SHALL BE SIZED BASED ON THE APPROVED TANK DIMENSIONS.
- 2. THE MANHOLE ARRANGEMENT IS BASED ON CONTAINMENT SOLUTIONS TANKS. ACTUAL MANHOLE ARRANGEMENT SHALL BE REDESIGNED AS NECESSARY BASED ON THE APPROVED TANK MANUFACTURER.
- 3. ALL CONDUITS SHALL BE PROVIDED WITH EXPLOSIONPROOF FITTINGS AND SEALED AS REQUIRED IN ACCORDANCE WITH NFPA 70.
- 4. ALLOW SLACK AT TANK IN ALL PIPING FOR SETTLING OF TANK.

# 1000 GALLON DOUBLE WALL OIL-WATER SEPARATOR DETAIL

NOT TO SCALE

JAB STATE OF CONNECTICUT **OCCUM** 103-247 THE INFORMATION, INCLUDING ESTIMATED QUANTITIES OF WORK, SHOWN ON THESE SHEETS IS BASED ON LIMITED INVESTIGATIONS BY THE STATE AND IS IN NO WAY WARRANTED TO INDICATE THE CONDITIONS OF ACTUAL QUANTITIES OCCUM MAINTENANCE OFFICE OF ENGINEERING JWW P-011 DRAWING TITLE: PPROVED BY: THE CONDITIONS OF ACTUAL QUANTITIES OF WORK WHICH WILL BE REQUIRED. **DEPARTMENT OF TRANSPORTATION FACILITY OIL-WATER** Amy N.O. SCALE AS NOTED 08.11 **SEPARATOR** REVISION DESCRIPTION SHEET NO. Plotted Date: 8/11/2015 Filename: ...\FD\_MSH\_MEC\_0103\_0247\_P011.dgn REV. DATE